


MAPLETON BRANCH LIBRARY READING GARDEN

DESIGN DEVELOPMENT

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SHEET NUMBER	SHEET NAME	
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PR-009	PROPOSED GARDEN ELEVATION SE	
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1 PROJECT LOCATION
N.T.S.



2 ZONING MAP - REZONED EFFECTIVE 02-27-2013 C 090154 ZMK
N.T.S.

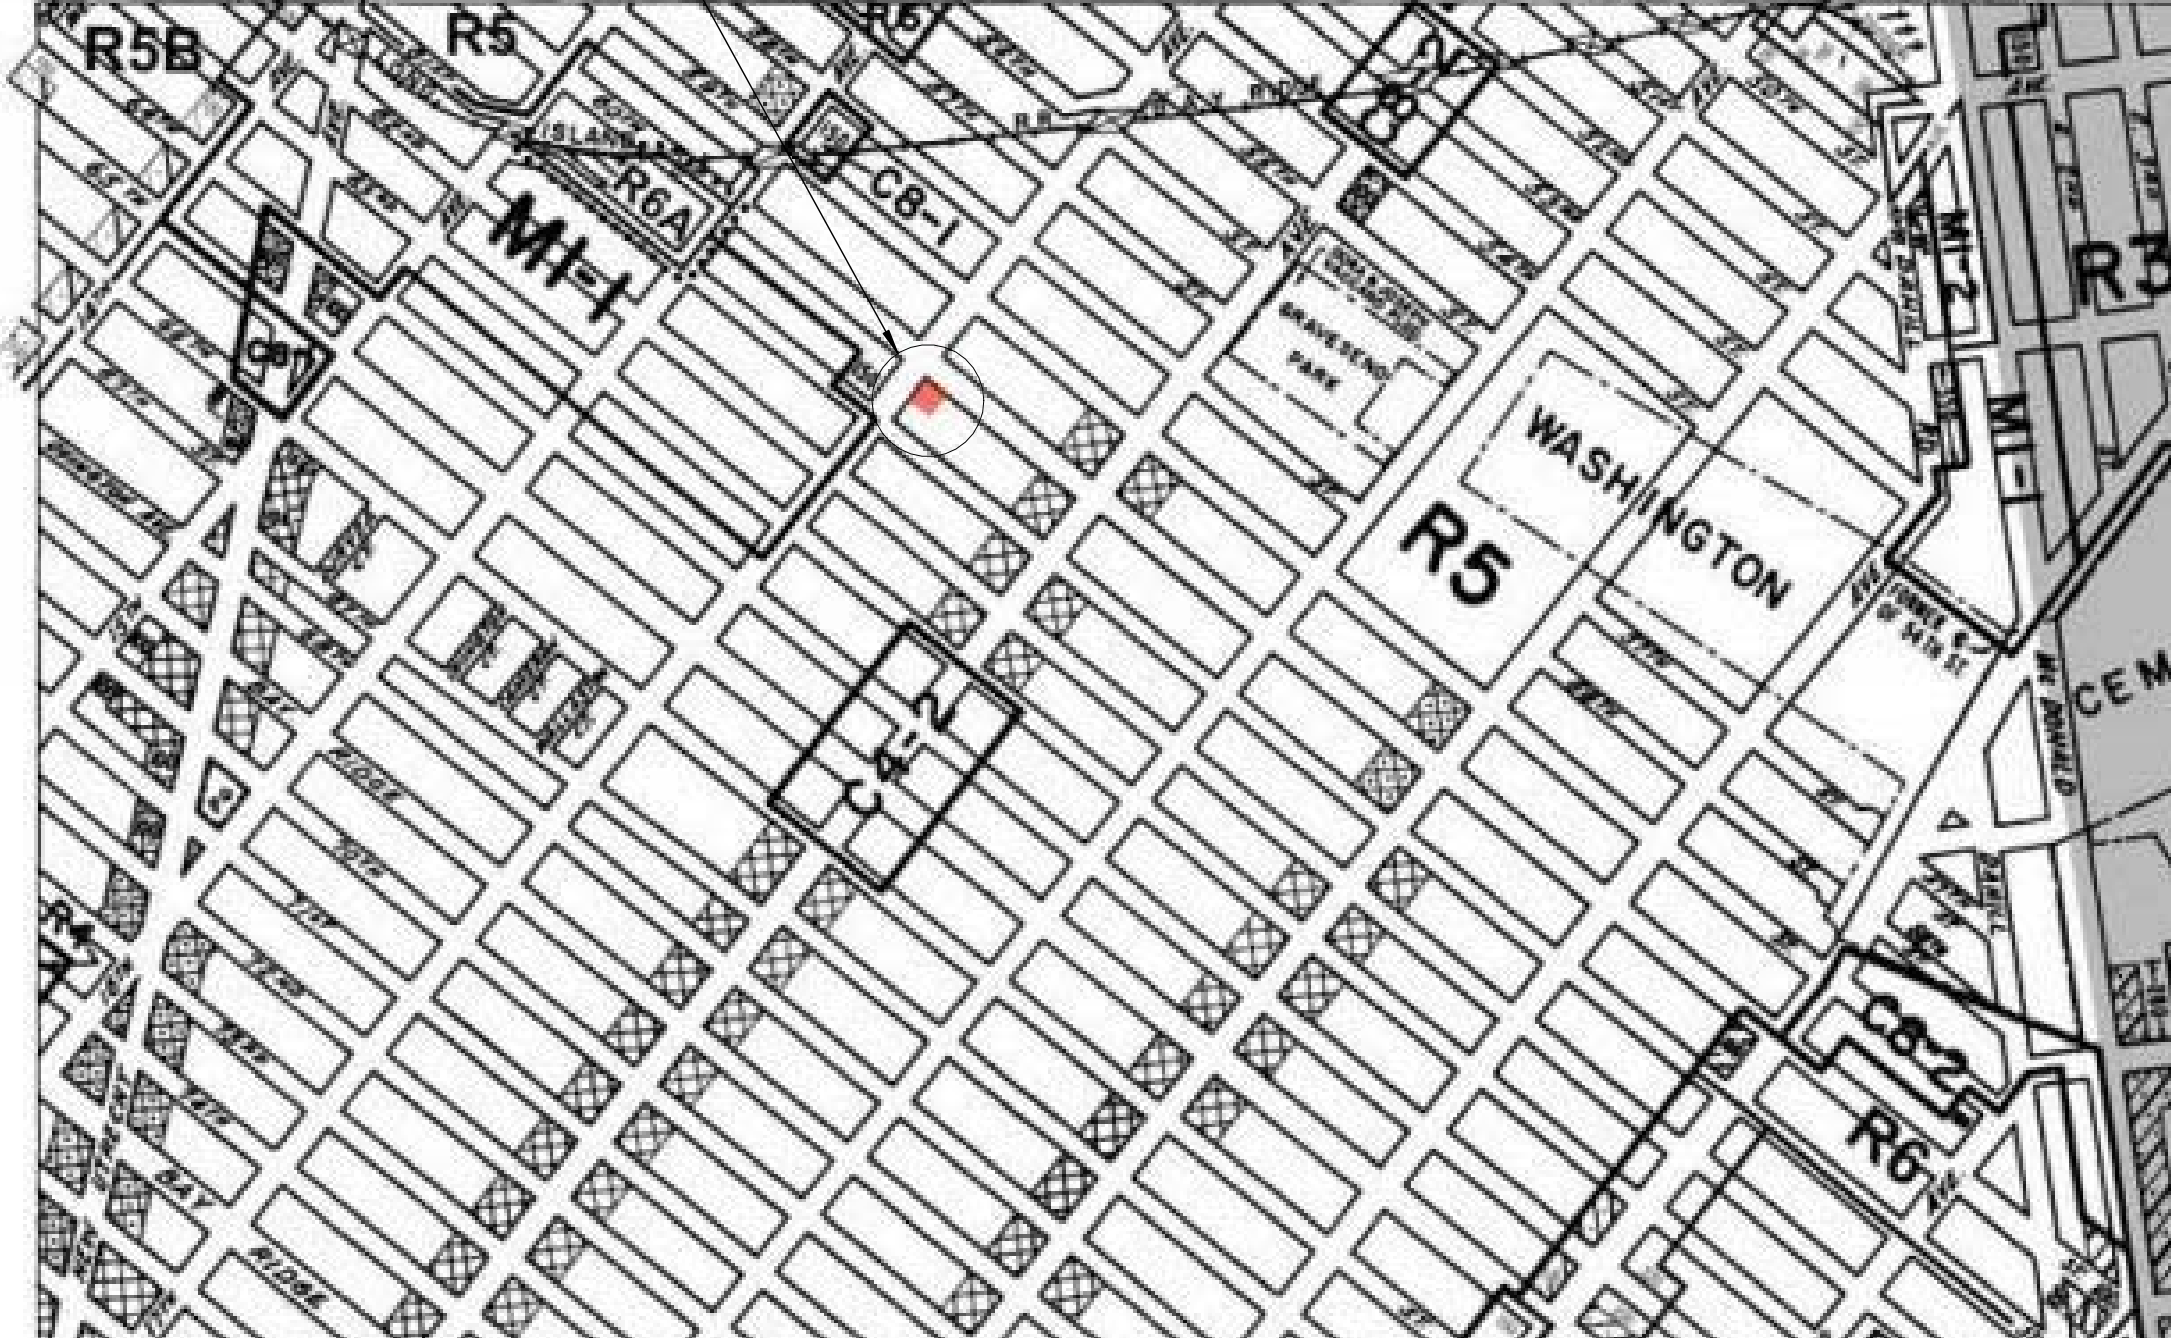

STRUCTURAL ENGINEER CONSULTANT Address City, ST 12345 T +1 XXX XXX XXXX	M.E.P. CONSULTANT Address City, ST 12345 T +1 XXX XXX XXXX
COST ESTIMATOR CONSULTANT Address City, ST 12345 T +1 XXX XXX XXXX	LIGHTING DESIGN CONSULTANT Address City, ST 12345 T +1 XXX XXX XXXX
LANDSCAPE ARCHITECT CONSULTANT Address City, ST 12345 T +1 XXX XXX XXXX	CIVIL / TRAFFIC ENGINEER CONSULTANT Address City, ST 12345 T +1 XXX XXX XXXX
GEOTECHNICAL ENGINEER CONSULTANT Address City, ST 12345 T +1 XXX XXX XXXX	ACOUSTICAL CONSULTANT CONSULTANT Address City, ST 12345 T +1 XXX XXX XXXX
VERTICAL TRANSPORTATION CONSULTANT Address City, ST 12345 T +1 XXX XXX XXXX	FUELING CONSULTANT CONSULTANT Address City, ST 12345 T +1 XXX XXX XXXX
ENVIRONMENTAL CONSULTANT CONSULTANT Address City, ST 12345 T +1 XXX XXX XXXX	SIGNAGE CONSULTANT CONSULTANT Address City, ST 12345 T +1 XXX XXX XXXX

DOB APPROVAL STAMP

DOB BSCAN STICKER

1	1	ISSUED FOR SCHEMATIC DESIGN	09/19/2017
ISSUE #	REV #	DESCRIPTION	DATE

FOR REFERENCE

Original drawing is 36" x 48" Do not scale contents of this drawing.

PROJECT STATUS
DESIGN DEVELOPMENT

THESE DRAWINGS ARE INSTRUMENTS OF SERVICE AND AS SUCH MAY NOT BE USED FOR OTHER PROJECTS, FOR ADDITIONS TO THIS PROJECT OR COMPLETION OF THIS PROJECT BY OTHERS.

SHEET TITLE
COVER SHEET

SEAL & SIGNATURE	DATE:	2017-09-15
	DRAWN BY:	ACS
	CHECKED BY:	JF
	DRAWING NUMBER:	

NOT FOR CONSTRUCTION

G-000.00


ABBREVIATIONS	
Abbreviation	Comments
A	
AD	AREA DRAIN
ADA	AMERICANS WITH DISABILITIES ACT
ADAAG	ADA ACCESSIBILITY GUIDELINES
ADD	ADDITIONAL
ADJ	ADJUSTABLE
ADxx	ACCESS DOOR
AFF	ABOVE FINISH FLOOR
ALT	ALTERNATE
ALUM	ALUMINUM
APPROX	APPROXIMATE
ARCH	ARCHITECTURAL
AUTO	AUTOMATIC
B	
BD	BOARD
BLDG	BUILDING
BLK	BLOCK
BSMT	BASEMENT
C	
CB	CATCH BASIN
CEM	CEMENT
CIP	CAST-IN-PLACE
CJ	CONTROL JOINT / CONSTRUCTION JOINT
CL	CENTER LINE
CLG	CEILING
CLR	CLEAR
CMU	CONCRETE MASONRY UNIT
COL	COLUMN
CONC	CONCRETE
COND	CONDITION
CONT	CONTINUOUS
COORD	COORDINATE
CENTR	CENTER
CTSK	COUNTERSUNK
CW	COLD WATER (PIPING)
D	
D	DEEP, DEPTH
DB	DECIBEL
DBL	DOUBLE
DEG	DEGREE
DEMO	DEMOLITION
DEPT	DEPARTMENT
DET	DETAIL
DIA	DIAMETER
DIM	DIMENSION
DN	DOWN
DR	DOOR
DS	DOWNSPOUT
DWG	DRAWING
E	
(E)	EXISTING
E	EAST
EA	EACH
EL	ELEVATION
ELEC	ELECTRICAL
EMERG	EMERGENCY
EP	ELECTRICAL PANELBOARD
EQ	EQUAL
EQUIP	EQUIPMENT
EXIST	EXISTING
EXP	EXPANSION
EXT	EXTERIOR

ABBREVIATIONS	
Abbreviation	Comments
F	
FA	FIRE ALARM
FB	FACE BRICK
FD	FLOOR DRAIN
FF	FINISH FLOOR
FF&E	FURNITURE, FINISHES & EQUIPMENT
FFEL	FINISH FLOOR ELEVATION
FIN	FINISH
FIXT	FIXTURE
FL	FLOOR
FO	FACE OF
FT	FEET
FTG	FOOTING
FURN	FURNITURE
G	
GA	GAUGE / GAGE
GALV	GALVANIZED
GC	GENERAL CONTRACTOR, GENERAL CONTRACT
GWB	GYPSUM WALLBOARD
H	
H	HIGH
HB	HOSE BIBB
HM	HOLLOW METAL (STEEL FRAME)
HORIZ	HORIZONTAL
HP	HIGH POINT
HR	HOUR
HSS	HOLLOW STRUCTURAL SECTION
HT	HEIGHT
HVAC	HEATING, VENTILATING, AIR CONDITIONING
HW	HOT WATER
I	
ICC	INTERNATIONAL CODE COUNCIL
ID	INSIDE DIAMETER / DIMENSION
IN	INCH
INCL	INCLUDED / INCLUDING
INFO	INFORMATION
INSUL	INSULATION
INT	INTERIOR
INTERM	INTERMEDIATE
IPS	INTERNATIONAL PIPE STANDARD
J	
JST	JOIST
JSxx	JOINT SEALANT
L	
L	LONG
LAB	LABORATORY
LAT	LATERAL
LB	POUND
LF	LINEAR FOOT
LN	LINE
LPT	LOW POINT
LT	LIGHT
LVR	LOUVER
M	
M	METER
MATL	MATERIAL
MAX	MAXIMUM
MDF	MEDIUM DENSITY FIBERBOARD
MECH	MECHANICAL


ABBREVIATIONS	
Abbreviation	Comments
M	
MEMB	MEMBRANE
MEP	MECHANICAL, ELECTRICAL, PLUMBING
MFR	MANUFACTURER
MH	MANHOLE
MIN	MINIMUM
MISC	MISCELLANEOUS
MM	MILLIMETER
MPxx	METAL PANEL
MTL	METAL
MULL	MULLION
N	
NA	NORTH
N	NOT APPLICABLE
NC	NOISE CRITERIA
NO	NOT IN CONTRACT
NUMBER	NUMBER
NOM	NOMINAL
NRC	NOISE REDUCTION COEFFICIENT
NTS	NOT TO SCALE
O	
OC	ON CENTER
OD	OUTSIDE DIAMETER/DIMENSION
OPH	OPPOSITE HAND
OPNG	OPENING
OPP	OPPOSITE
OPPHD	OPPOSITE HAND
OUTS	OUTSIDE
P	
PAR	PARALLEL
PARTN	PARTITION
PAV	PAVING
PAV	PAVER
PERF	PERFORATED
PERIM	PERIMETER
PERP	PERPENDICULAR
PL	PLATE
PLAxx	PLASTER
PLxx	PLASTIC LAMINATE
PLYWD	PLYWOOD
PREFAB	PREFABRICATED
PROJ	PROJECT
PSF	POUNDS PER SQUARE FOOT
PT	POINT
PTD	PAINTED
PTN	PARTITION
PTxx	PAINT
Q	
QC	QUALITY CONTROL
QT	QUARRY TILE
QTY	QUANTITY
R	
(R)	RELOCATED
R	RADIUS OR RISER (PIPING)
RCP	REFLECTED CEILING PLAN
RD	ROOF DRAIN
RECOM	RECOMMENDED
REF	REFERENCE
REFL	REFLECTED / REFLECTIVE / REFLECT
REG	REGISTER
REINF	REINFORCED / REINFORCING
REM	REMOVABLE
REQ	REQUIRE / REQUIRED

ABBREVIATIONS	
Abbreviation	Comments
R	
REV	REVISION / REVISED
RFxx	RESILIENT FLOOR
RM	ROOM
RO	ROUGH OPENING
RSxx	ROOFING SYSTEM
RTD	RATED
S	
S	SOUTH
SAN	SANITARY
SCHED	SCHEDULE
SD	STORM DRAIN
SECT	SECTION
SF	SQUARE FEET/FOOT
SIM	SIMILAR
SP	STANDPIPE
SPEC	SPECIFICATION
SQ	SQUARE
SS	STAINLESS STEEL
SSE	STRUCTURE SLAB ELEVATION
STD	STANDARD
STOR	STORAGE
STRUC	STRUCTURAL
STxx	STONE
SUSP	SUSPENDED
SYS	SYSTEM
T	
T	TREAD / THERMOSTAT
TC	TOP OF CURB
TCONC	TOP OF CONCRETE
TEMP	TEMPERATURE
THK	THICKNESS
THRES	THRESHOLD
THRU	THROUGH
TLxx	TILING
TO	TOP OF (SEE OTHER WORD)
TOS	TOP OF SLAB, TOP OF STRUCTURE
TOSTL	TOP OF STEEL
TP	TOP OF PAVEMENT
TW	TOP OF WALL
TYP	TYPICAL
Tzxx	TERRAZZO
U	
UL	UNDERWRITERS LABORATORY
UNFIN	UNFINISHED
UON	UNLESS OTHERWISE NOTED
V	
VERT	VERTICAL
VEST	VESTIBULE
VIF	VERIFY IN FIELD
VR	VAPOR RETARDER
W	
W	WIDE, WIDTH, WEST
W	WITH
W/O	WITHOUT
Wbxx	WALL BASE
WD	WOOD
WDS	WOOD SCREW
WP	WATERPROOFING
WPM	WATERPROOF MEMBRANE
WPSxx	WATERPROOFING SYSTEM
WT	WEIGHT
WTxx	WINDOW TREATMENT


SYMBOLS LIST

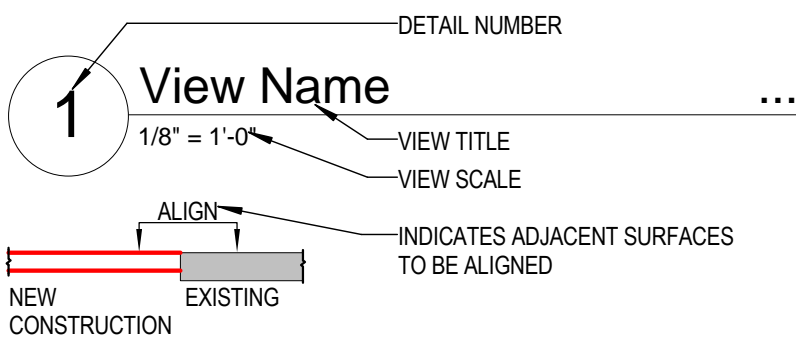

ELEMENT IDENTIFICATION

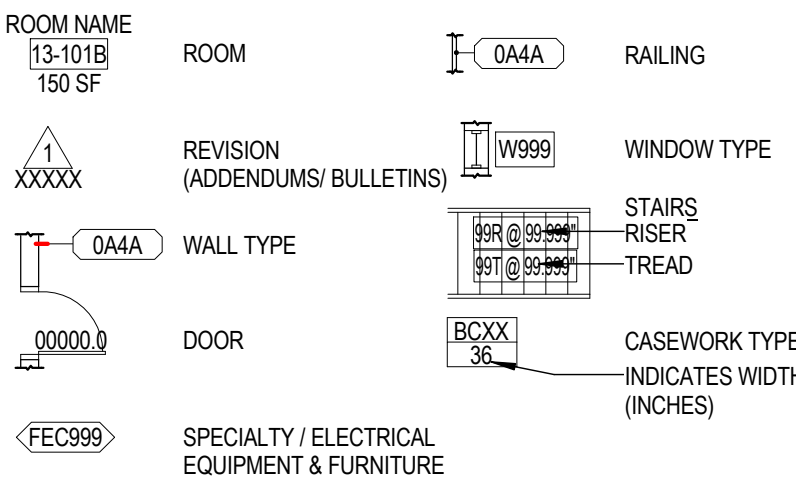

SURFACE IDENTIFICATION

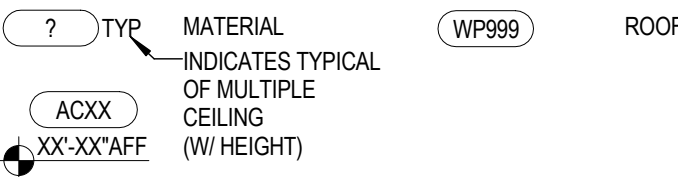

GENERAL NOTES

A. GENERAL NOTES:

- THE CONTRACTOR SHALL PROVIDE COMPLETE PROJECT SYSTEMS AND COMPONENTS AND COMPLY WITH ALL REQUIREMENTS INDICATED ON THE PROJECT DOCUMENTS.
- WORK WITHIN THE AREA BOUNDARIES INDICATED IN THE PROJECT DOCUMENTS AND COMPLY WITH ALL APPLICABLE BUILDING CODE, REGULATION, & ORDINANCE REQUIREMENTS. OCCUPANTS ADJACENT TO THE PROJECT AREA BOUNDARIES SHALL CONTINUE UNINTERRUPTED OCCUPANCY DURING CONSTRUCTION OF THE PROJECT.
- VERIFY FIELD CONDITIONS AND COORDINATION WITH THE PROJECT DOCUMENTS PRIOR TO PROCEEDING WITH THE WORK.
- COORDINATE THE WORK WITH ALL REQUIREMENTS INDICATED IN THE PROJECT DOCUMENTS.
- PERFORM THE WORK AT THE PROJECT SITE DURING NORMAL BUSINESS HOURS, UNLESS OTHERWISE NOTED.
- THE CONTRACTOR SHALL MANAGE & COORDINATE WORK OF ALL TRADES & SUBCONTRACTORS.
- COORDINATE THE WORK WITH EQUIPMENT, FURNISHINGS AND SYSTEMS PROVIDED BY THE OWNER.
- THE DRAWINGS, SPECIFICATIONS, AND CONSTRUCTION NOTES ARE AN INHERENT PART OF THE CONTRACT DOCUMENTS. IN THE EVENT OF A CONFLICT AMONG THE DRAWINGS, SPECIFICATIONS, AND/OR NOTES, ASSUME THE MORE EXPENSIVE OPTION FOR THE PURPOSES OF BIDDING, AND BRING EACH CONFLICT TO THE ARCHITECT'S ATTENTION BEFORE STARTING THE WORK. THE ARCHITECT RETAINS THE RIGHT TO SELECT BETWEEN CONFLICTING OPTIONS. SPECIFICATIONS AND DRAWINGS ARE COMPLEMENTARY AND WHAT IS REQUIRED BY EITHER IS BINDING ON BOTH.
- CONTRACTOR TO CHECK AND VERIFY DIMENSIONS AND CORRELATE CONTRACT DOCUMENTS WITH JOB CONDITIONS BEFORE COMMENCEMENT OF WORK AND SHALL BE RESPONSIBLE FOR THEIR ACCURACY. REPORT DISCREPANCIES BETWEEN FIELD CONDITIONS AND THE DOCUMENTS OR WITHIN THE DOCUMENTS TO THE ARCHITECT IMMEDIATELY.
- DO NOT SCALE DRAWINGS. DIMENSIONS SHOWN ARE TO FACE OF ELEMENTS, UNLESS SPECIFICALLY NOTED OTHERWISE.
- PREPARE "COORDINATION DRAWINGS" THAT REPRESENT THE WORK OF TRADES INVOLVED IN THE PROJECT, AND COORDINATE THE INSTALLATION OF THEIR WORK, TO AVOID CONFLICTS AND MISALIGNMENTS. CONFLICTS SHALL BE RESOLVED PRIOR TO SUBMISSION OF SHOP DRAWINGS FOR THE ARCHITECT'S (OR ENGINEER'S) REVIEW AND PRIOR TO EXECUTION OF WORK.
- EXECUTE CUTTING AND PATCHING TO RESTORE EXISTING FINISHES TO THEIR ORIGINAL CONDITION.
- REPAIR EXISTING CONTIGUOUS CONSTRUCTION THAT IS TO REMAIN TO ALIGN, FIT AND ADJOIN NEW WORK. WORK SHALL INCLUDE, BUT NOT LIMITED TO PREPARING SURFACES TO RECEIVED NEW FINISHES.
- PATCH AND REPAIR EXISTING ELEMENTS DAMAGED DURING CONSTRUCTION TO MATCH EXISTING CONSTRUCTION IN ALL RESPECTS, INCLUDING BUT NOT LIMITED TO ASSEMBLY, FINISHES, AND FIRE PROTECTION.
- PROTECT AND MAINTAIN ALL EXISTING ELEMENTS TO REMAIN WITHIN AND ADJACENT TO CONSTRUCTION.
- MAINTAIN TREE PROTECTION.

DEMOLITION NOTES:

- THE EXTENT OF DEMOLITION IS SHOWN FOR BASIC SCOPE. CONTRACTOR IS RESPONSIBLE FOR DEMOLITION, REMOVAL AND PREPARATION OF EXISTING CONDITIONS TO FACILITATE THE NEW CONSTRUCTION WITHOUT LIMITATION.
- ALL DRAINS SHALL BE PROTECTED WITH FILTER FABRIC THROUGHOUT THE CONSTRUCTION PERIOD AND UNTIL ALL DISTURBED AREAS ARE PERMANENTLY STABILIZED.
- GENERATION OF DUST SHALL BE KEPT TO A MINIMUM BY LIMITING THE EXPOSED SOILS AND ESTABLISHING COVER IN THESE AREAS AS SOON AS POSSIBLE. ADDITIONAL, AND/OR TEMPORARY METHODS TO MINIMIZE DUST MAY INCLUDE WETTING, SPRAY ADHESIVES, STONE COVERING AND BARRIERS.
- ALL EROSION AND SEDIMENT CONTROL DEVICES MUST BE INSPECTED ON A WEEKLY BASIS AND ANY DAMAGE INCURRED MUST BE RECTIFIED IMMEDIATELY.
- ALL CONSTRUCTION VEHICLES HALLING MATERIALS INTO AND OUT OF THE CONSTRUCTION AREA SHALL HAVE A SECURED TARP OVER MATERIALS TO PREVENT SEDIMENT POLLUTION ON ROADWAYS.

C. DEFINITIONS:

- "TYPICAL" OR "TYP" INDICATES IDENTICAL COMPLETE SYSTEM SHALL BE PROVIDED FOR EACH OCCURRENCE OF THE CONDITION NOTED.
- "SIMILAR" INDICATES COMPLETE SYSTEM AND COMPONENTS SHALL BE PROVIDED COMPARABLE TO THE CHARACTERISTICS FOR THE CONDITION NOTED.
- "AS REQUIRED" INDICATES COMPONENTS REQUIRED TO COMPLETE THE NOTED, SYSTEM AS INDICATED IN THE PROJECT DOCUMENTS, SHALL BE PROVIDED.
- "ALIGN" INDICATES ACCURATELY PROVIDE FINISH FACES OF MATERIALS IN STRAIGHT, TRUE AND PLUMB RELATION TO ADJACENT MATERIALS.


D. DIMENSIONS:

- MINIMUM DIMENSIONS FOR ACCESSIBILITY CLEARANCES AND BUILDING CODE REQUIREMENTS SHALL BE MAINTAINED.
- FLOOR ELEVATIONS ARE INDICATED TO THE TOP OF FINISH FLOOR, UNLESS OTHERWISE NOTED.
- VERTICAL DIMENSIONS ARE INDICATED FROM THE FLOOR ELEVATION TO FACE OF FINISHED MATERIAL, UNLESS NOTED ABOVE FINISH FLOOR - AFF.
- DIMENSIONS SHOWN ON THE DRAWINGS SHALL INDICATE THE REQUIRED SIZE, CLEARANCE AND DIMENSIONAL RELATIONSHIP BETWEEN PROJECT SYSTEMS AND COMPONENTS. DIMENSIONS SHALL NOT BE DETERMINED BY SCALING THE DRAWINGS.

E. ZONING:

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National Flood Hazard Layer FIRMette

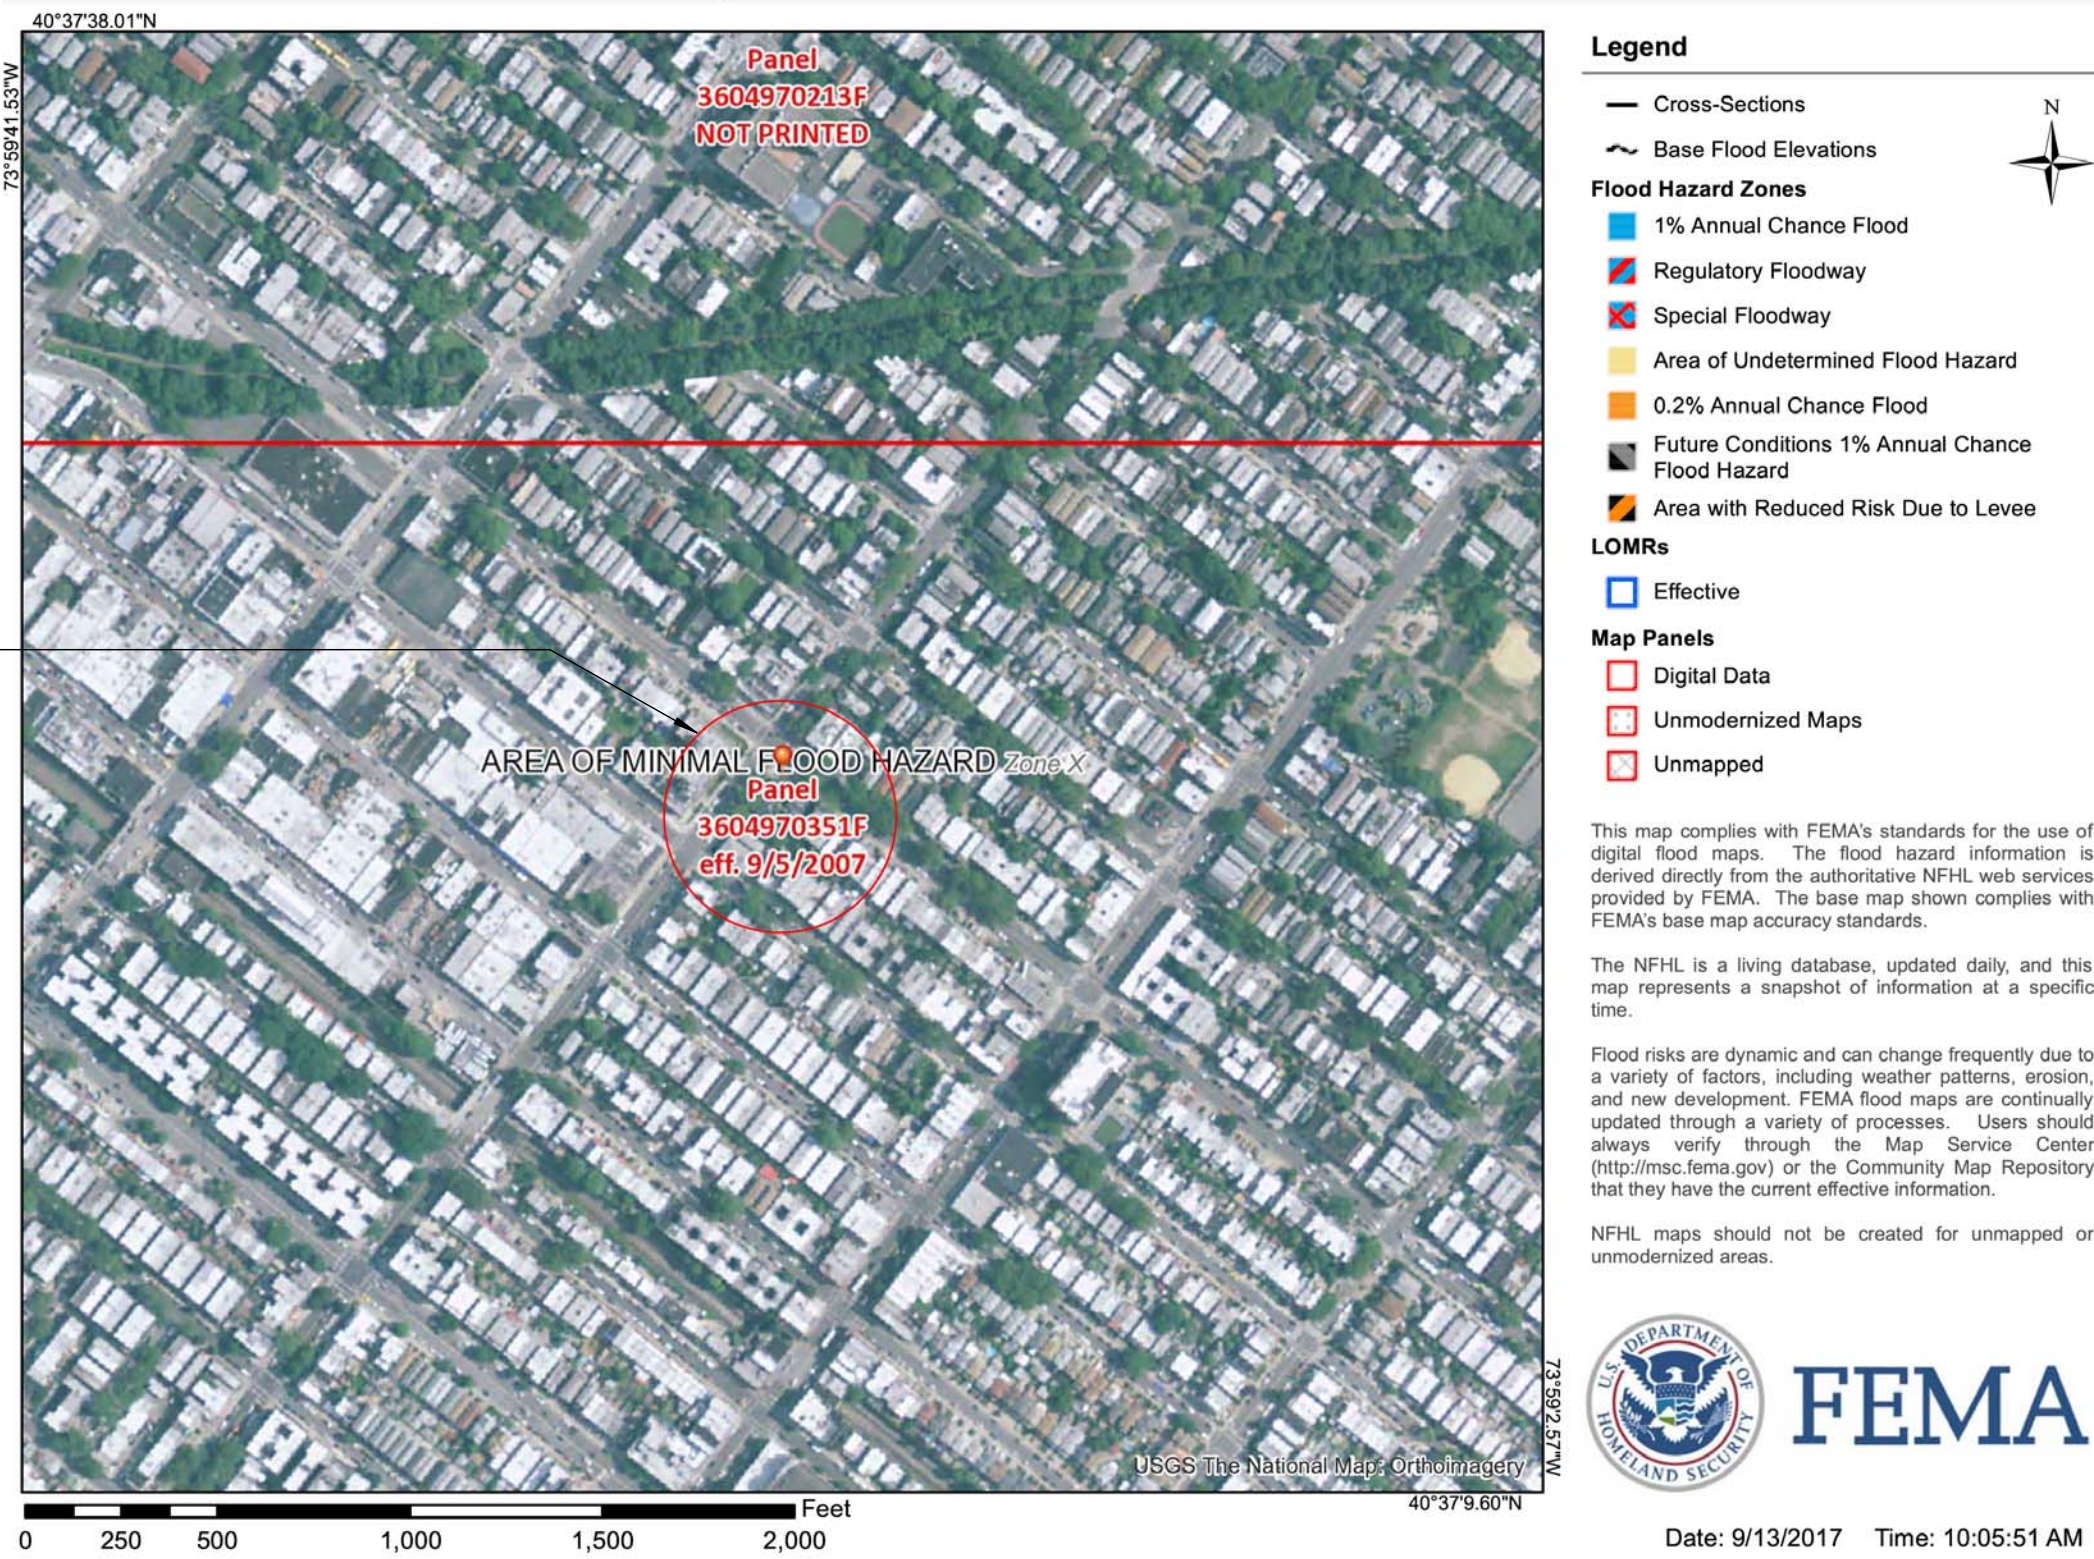

PROJECT LOCATION

3

FEMA FLOOD MAP
N.T.S.

PANEL 3604970351F 9/13/17

NOTE: FLOOD MAP NOT APPLICABLE



PROJECT
MAPLETON BRANCH LIBRARY
READING GARDEN

1702 60TH STREET
BROOKLYN, NY 11204
FOR THE BROOKLYN PUBLIC LIBRARY
FMSD NO. LBC17MPGD



Department of
Design and
Construction
In.House
Design Studio
DIVISION OF PUBLIC BUILDINGS
30-30 Thompson Ave., Long Island City, NY 11101

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COST ESTIMATOR CONSULTANT Address City, ST 12345 T +X XXX XXX XXXXX	LIGHTING DESIGN CONSULTANT Address City, ST 12345 T +X XXX XXX XXXXX
LANDSCAPE ARCHITECT CONSULTANT Address City, ST 12345 T +X XXX XXX XXXXX	CIVIL TRAFFIC ENGINEER CONSULTANT Address City, ST 12345 T +X XXX XXX XXXXX
GEOTECHNICAL ENGINEER CONSULTANT Address City, ST 12345 T +X XXX XXX XXXXX	ACOUSTICAL CONSULTANT CONSULTANT Address City, ST 12345 T +X XXX XXX XXXXX
VERTICAL TRANSPORTATION CONSULTANT Address City, ST 12345 T +X XXX XXX XXXXX	FUELING CONSULTANT CONSULTANT Address City, ST 12345 T +X XXX XXX XXXXX
ENVIRONMENTAL CONSULTANT CONSULTANT Address City, ST 12345 T +X XXX XXX XXXXX	SIGNAGE CONSULTANT CONSULTANT Address City, ST 12345 T +X XXX XXX XXXXX

DOE APPROVAL STAMP

DOE BSCAN STICKER

PROJECT STATUS

DESIGN DEVELOPMENT

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SHEET TITLE

NOTES, ABBREVIATIONS, AND FLOOD MAP

NOT FOR CONSTRUCTION

G-001.00

SEAL & SIGNATURE


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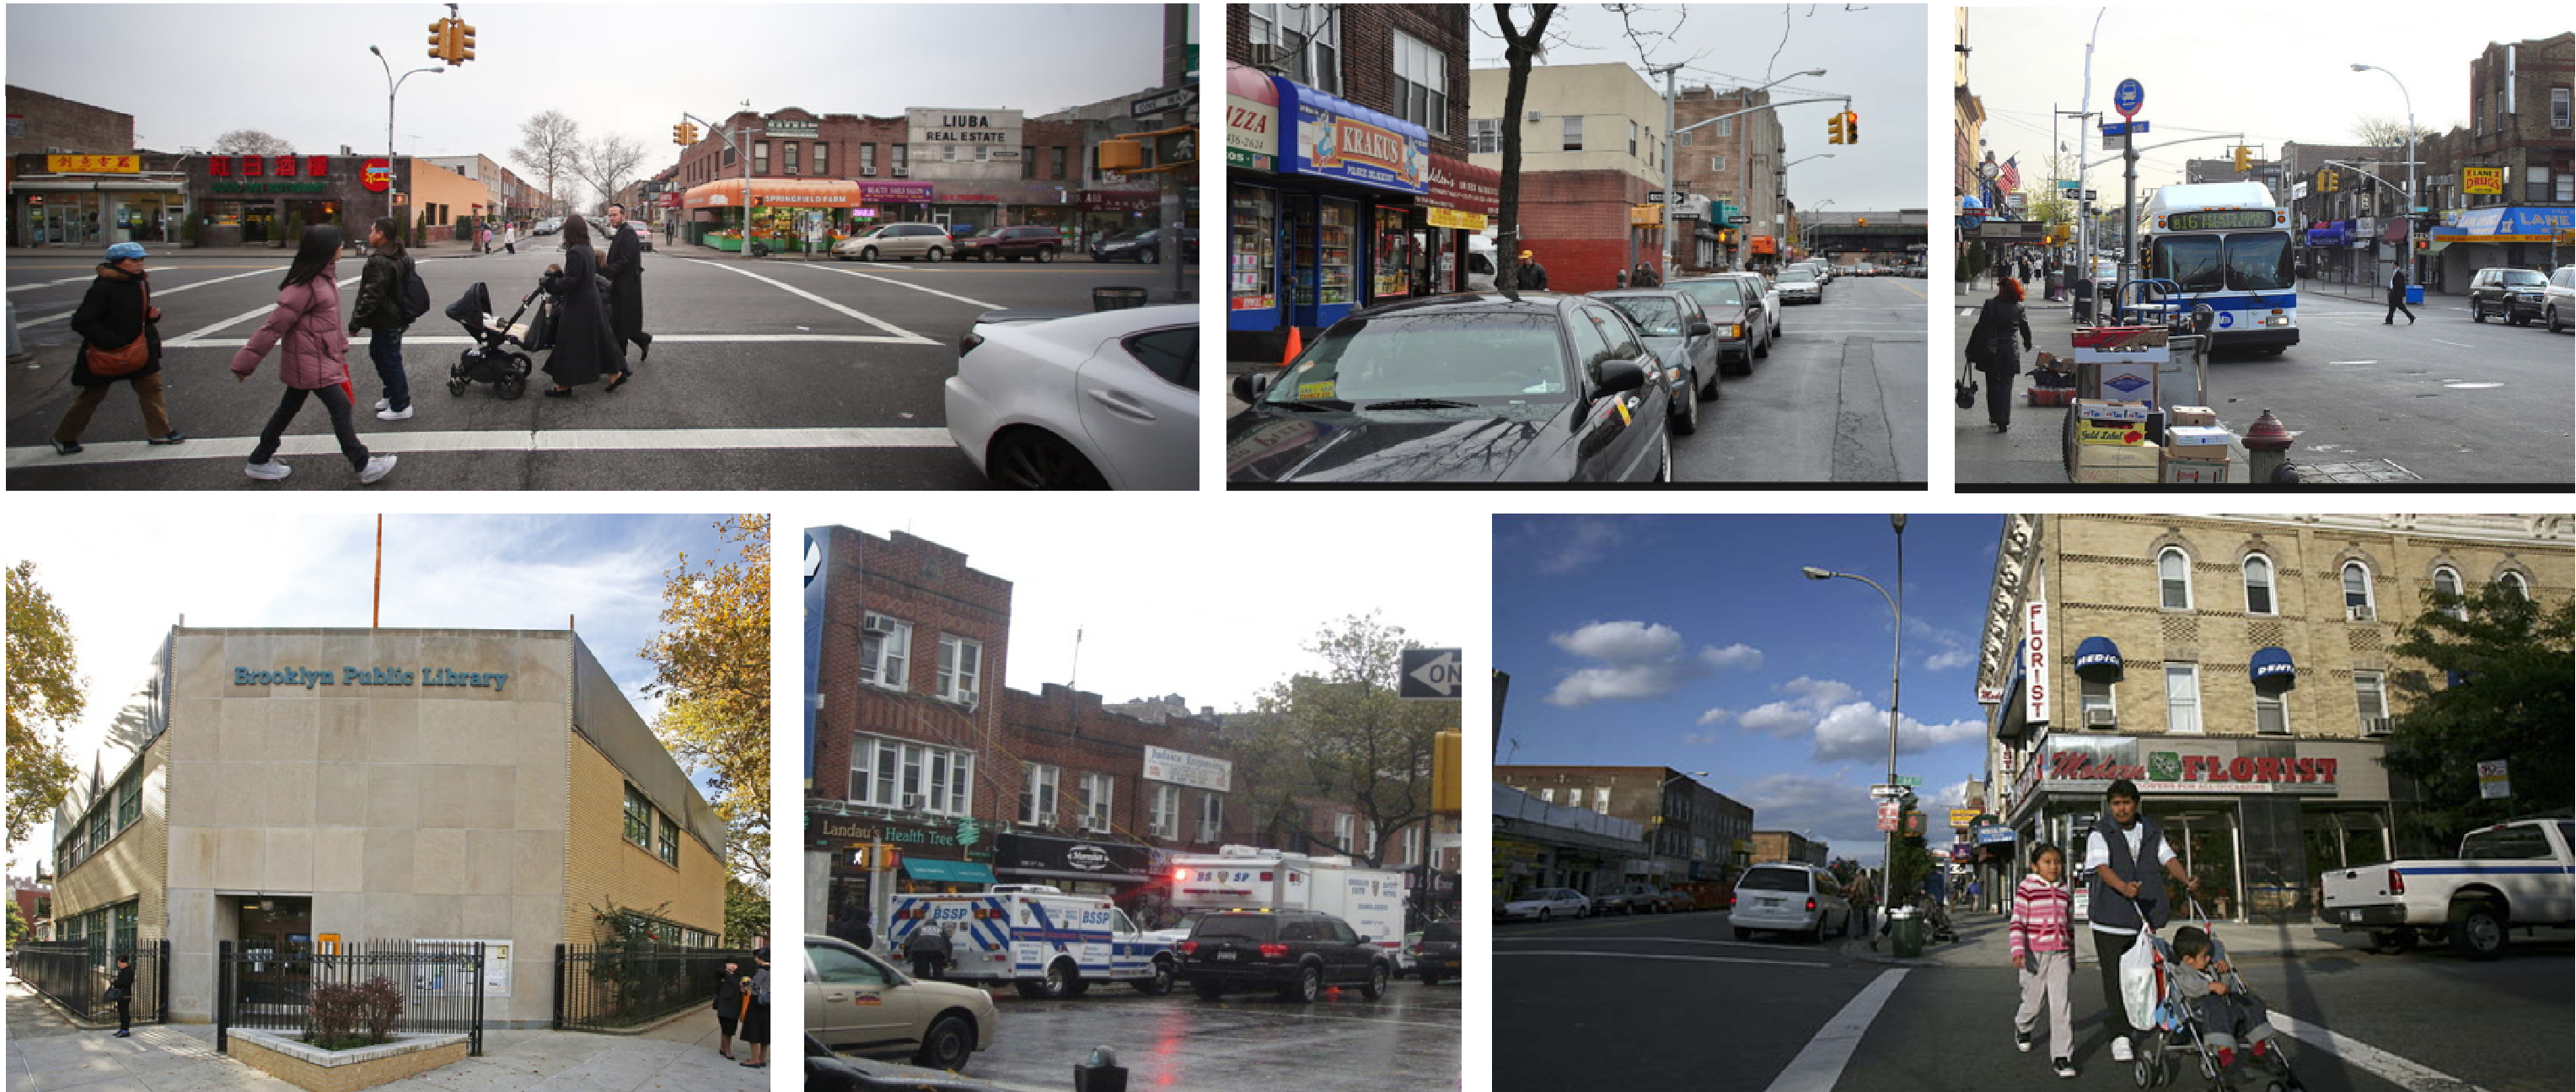
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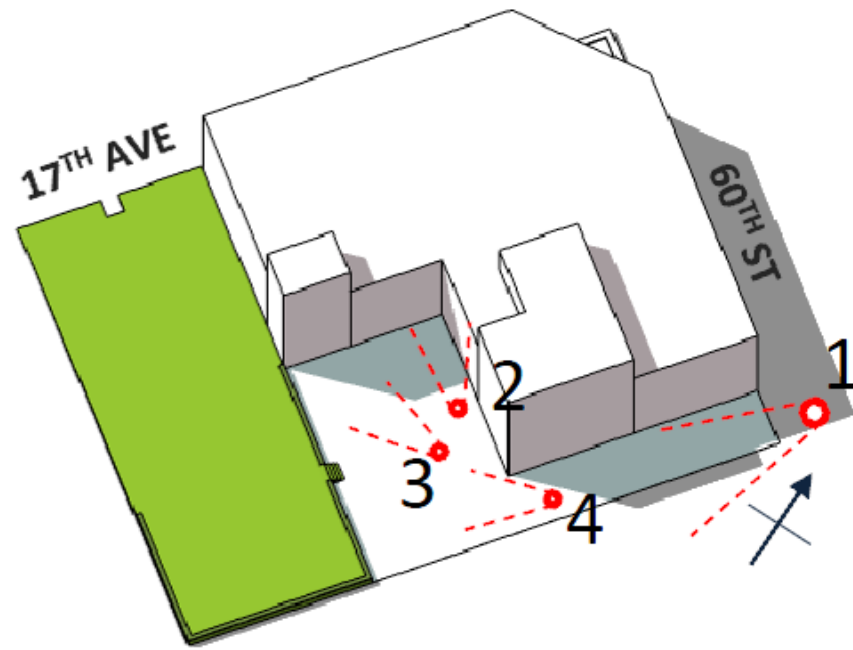
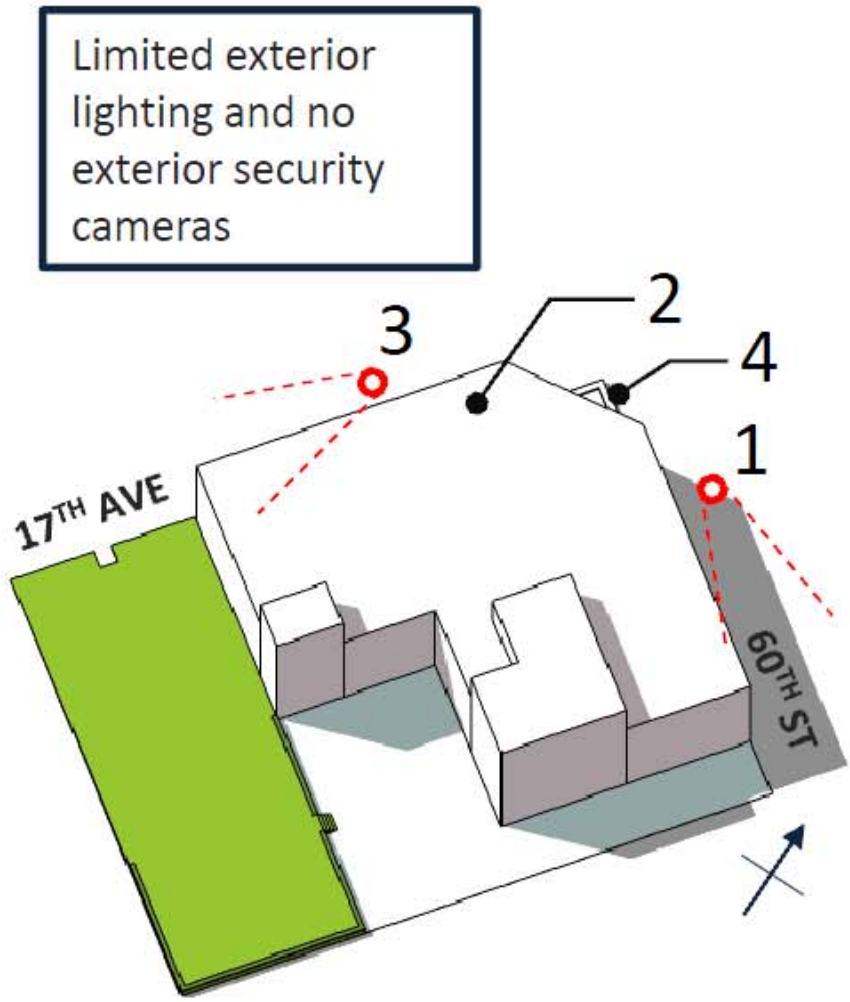




3 NEIGHBORHOOD IMAGES
N.T.S.



2 LAWN AREA REFERENCE IMAGES
N.T.S.

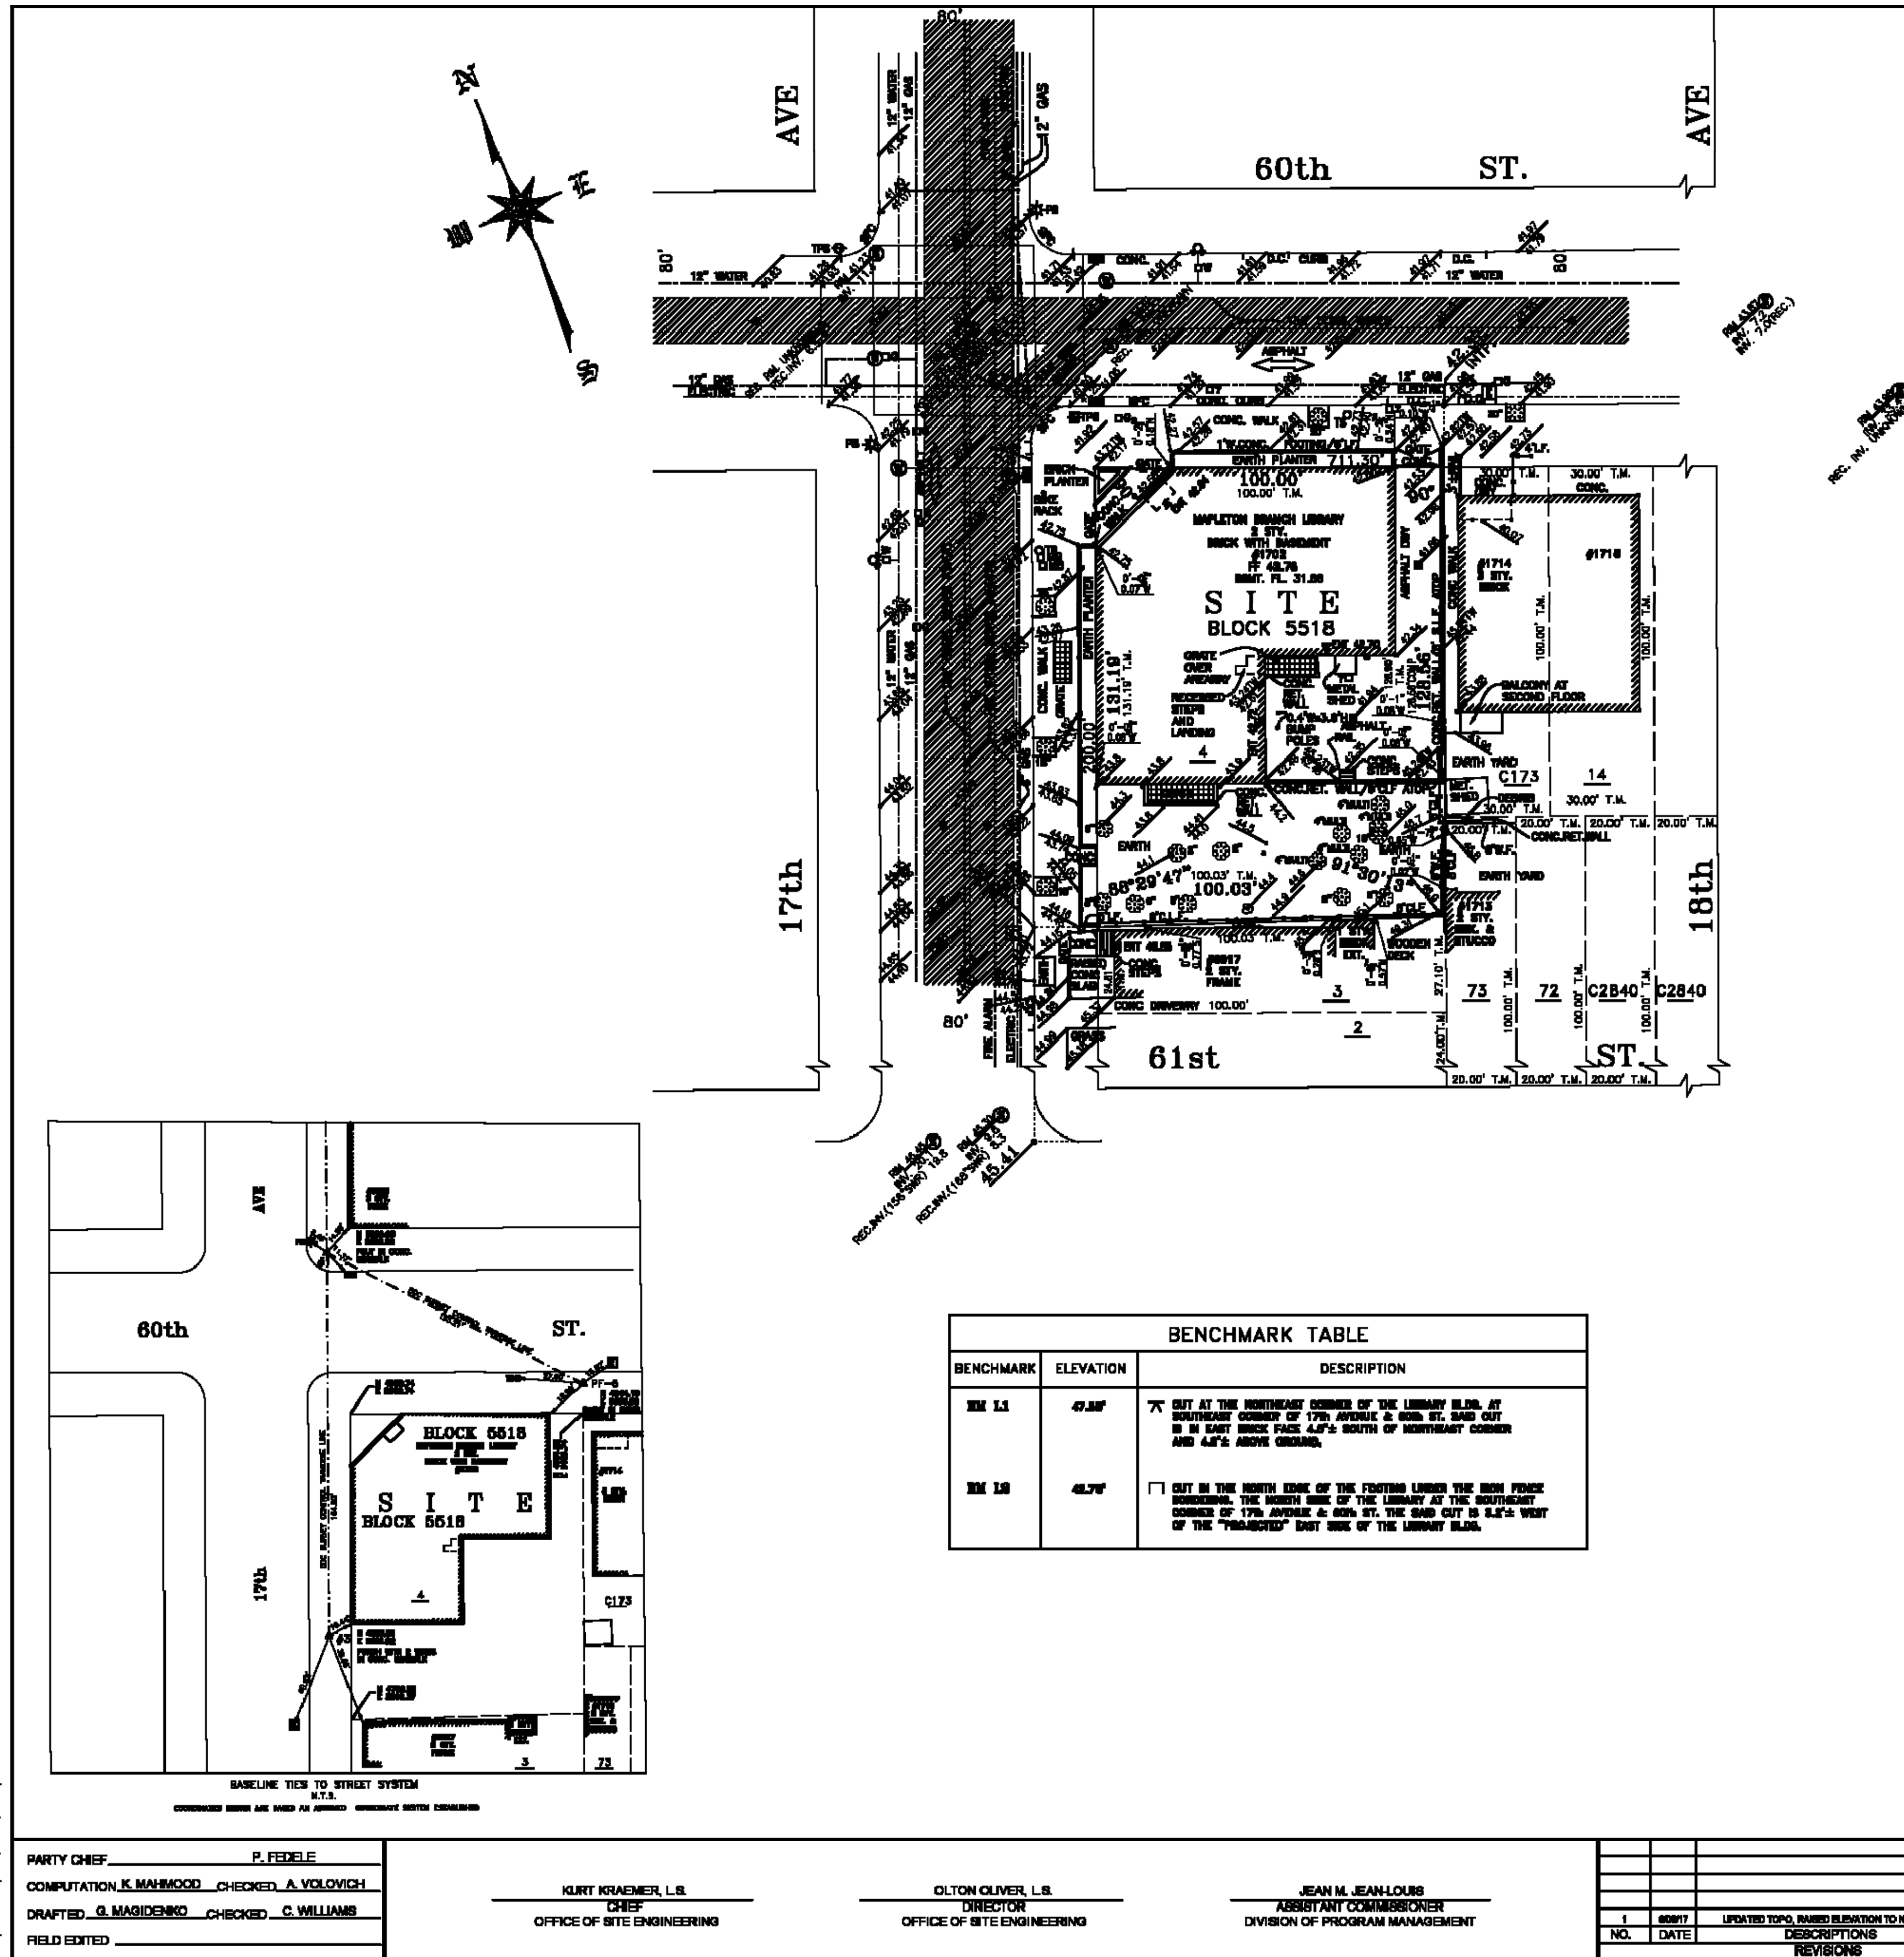

1 SITE REFERENCE IMAGES
N.T.S.

STRUCTURAL ENGINEER CONSULTANT Address City, ST 12345 T +1 XXX XXX XXXX	M.E.P. CONSULTANT Address City, ST 12345 T +1 XXX XXX XXXX
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ENVIRONMENTAL CONSULTANT CONSULTANT Address City, ST 12345 T +1 XXX XXX XXXX	SIGNAGE CONSULTANT CONSULTANT Address City, ST 12345 T +1 XXX XXX XXXX

DOB APPROVAL STAMP

DOB SCAN STICKER

ISSUE	REV	DESCRIPTION	DATE
1	1	ISSUED FOR SCHEMATIC DESIGN	09/19/2017
2	1		
3	1		
4	1		
5	1		
6	1		
7	1		
8	1		
9	1		
10	1		
11	1		
12	1		
13	1		
14	1		
15	1		
16	1		
17	1		
18	1		
19	1		
20	1		

FOR REFERENCE
Original drawing is 30" x 42" Do not scale contents of this drawing
PROJECT STATUS
DESIGN DEVELOPMENT
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SHEET TITLE
PHOTO REFERENCES

SEAL & SIGNATURE
DATE: 2017-09-15
DRAWN BY: ACS
CHECKED BY: JF
DRAWING NUMBER:

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G-101.00


STRUCTURAL ENGINEER CONSULTANT Address City, ST 12345 T +X XXX XXX XXXX	M.E.P. CONSULTANT Address City, ST 12345 T +X XXX XXX XXXX
COST ESTIMATOR CONSULTANT Address City, ST 12345 T +X XXX XXX XXXX	LIGHTING DESIGN CONSULTANT Address City, ST 12345 T +X XXX XXX XXXX
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VERTICAL TRANSPORTATION CONSULTANT Address City, ST 12345 T +X XXX XXX XXXX	FUELING CONSULTANT CONSULTANT Address City, ST 12345 T +X XXX XXX XXXX
ENVIRONMENTAL CONSULTANT CONSULTANT Address City, ST 12345 T +X XXX XXX XXXX	SIGNAGE CONSULTANT CONSULTANT Address City, ST 12345 T +X XXX XXX XXXX

DOE APPROVAL STAMP

DOE BSCAN STICKER

1	1	ISSUED FOR SCHEMATIC DESIGN	09/19/2017
ISSUE #	REV #	DESCRIPTION	DATE

FOR REFERENCE

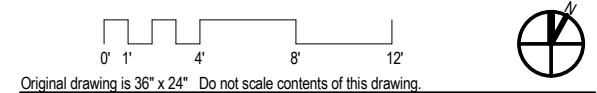

PROJECT STATUS
DESIGN DEVELOPMENT


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SHEET TITLE
SITE PLAN

SEAL & SIGNATURE
DATE: 2017-09-15
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DRAWING NUMBER:

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CONSTRUCTION


A-001.00

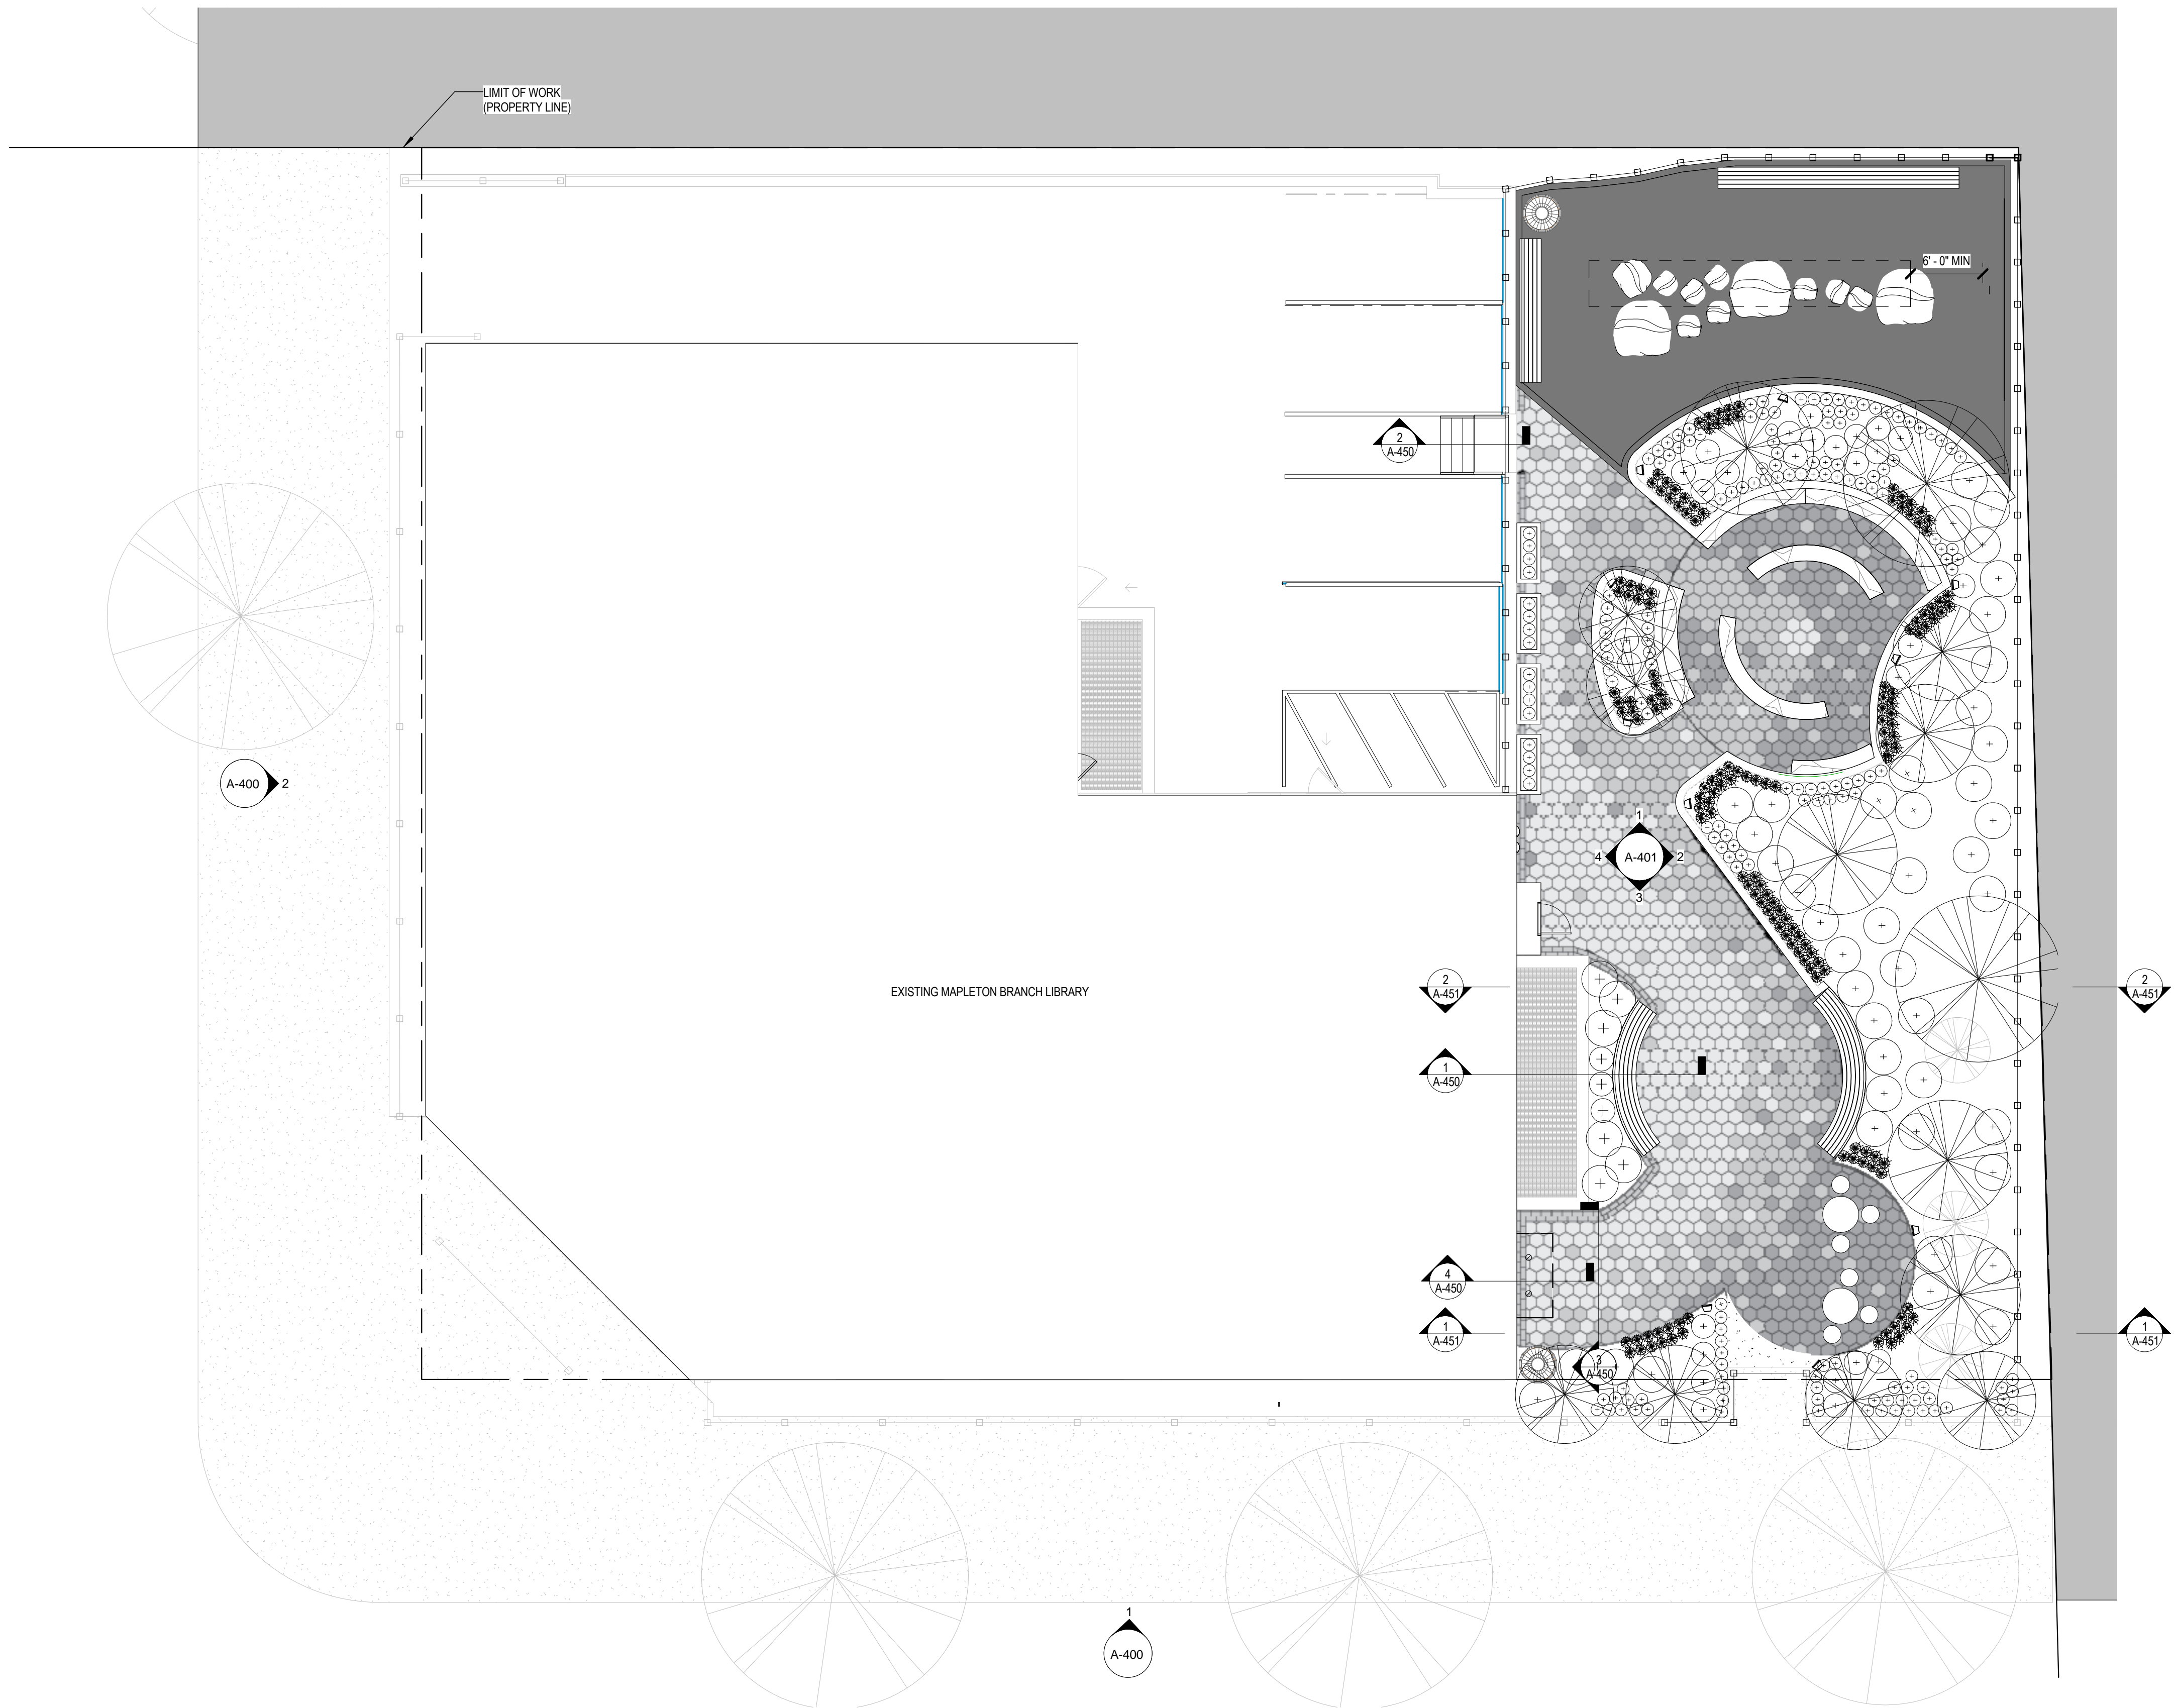

1 SITE PLAN
1/8" = 1'-0"

PROJECT
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READING GARDEN

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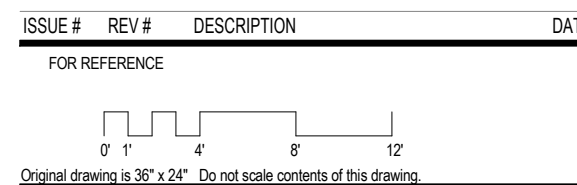
Department of
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Design Studio
DIVISION OF PUBLIC BUILDINGS
30-30 Thomson Ave., Long Island City, NY 11101

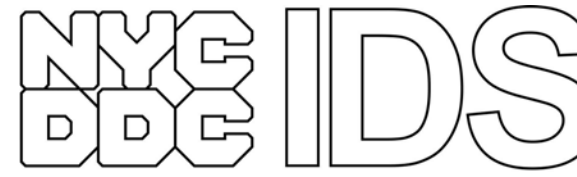STRUCTURAL ENGINEER CONSULTANT Address City, ST 12345 T +X XXX XXX XXXX	M.E.P. CONSULTANT Address City, ST 12345 T +X XXX XXX XXXX
COST ESTIMATOR CONSULTANT Address City, ST 12345 T +X XXX XXX XXXX	LIGHTING DESIGN CONSULTANT Address City, ST 12345 T +X XXX XXX XXXX
LANDSCAPE ARCHITECT CONSULTANT Address City, ST 12345 T +X XXX XXX XXXX	CIVIL TRAFFIC ENGINEER CONSULTANT Address City, ST 12345 T +X XXX XXX XXXX
GEOTECHNICAL ENGINEER CONSULTANT Address City, ST 12345 T +X XXX XXX XXXX	ACOUSTICAL CONSULTANT CONSULTANT Address City, ST 12345 T +X XXX XXX XXXX
VERTICAL TRANSPORTATION CONSULTANT Address City, ST 12345 T +X XXX XXX XXXX	FUELING CONSULTANT CONSULTANT Address City, ST 12345 T +X XXX XXX XXXX
ENVIRONMENTAL CONSULTANT CONSULTANT Address City, ST 12345 T +X XXX XXX XXXX	SIGNAGE CONSULTANT CONSULTANT Address City, ST 12345 T +X XXX XXX XXXX

DOB APPROVAL STAMP


DOB BSCAN STICKER

ISSUE #	REV #	DESCRIPTION	DATE
FOR REFERENCE			
PROJECT STATUS			
DESIGN DEVELOPMENT			
THESE DRAWINGS ARE INSTRUMENTS OF SERVICE AND AS SUCH MAY NOT BE USED FOR OTHER PROJECTS, FOR ADDITIONS TO THIS PROJECT OR COMPLETION OF THIS PROJECT BY OTHERS.			
SHEET TITLE			
ENLARGED GARDEN AND GEOMETRIC PLAN			




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DATE: 2017-09-15
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CHECKED BY: Checker
DRAWING NUMBER: A-002.00

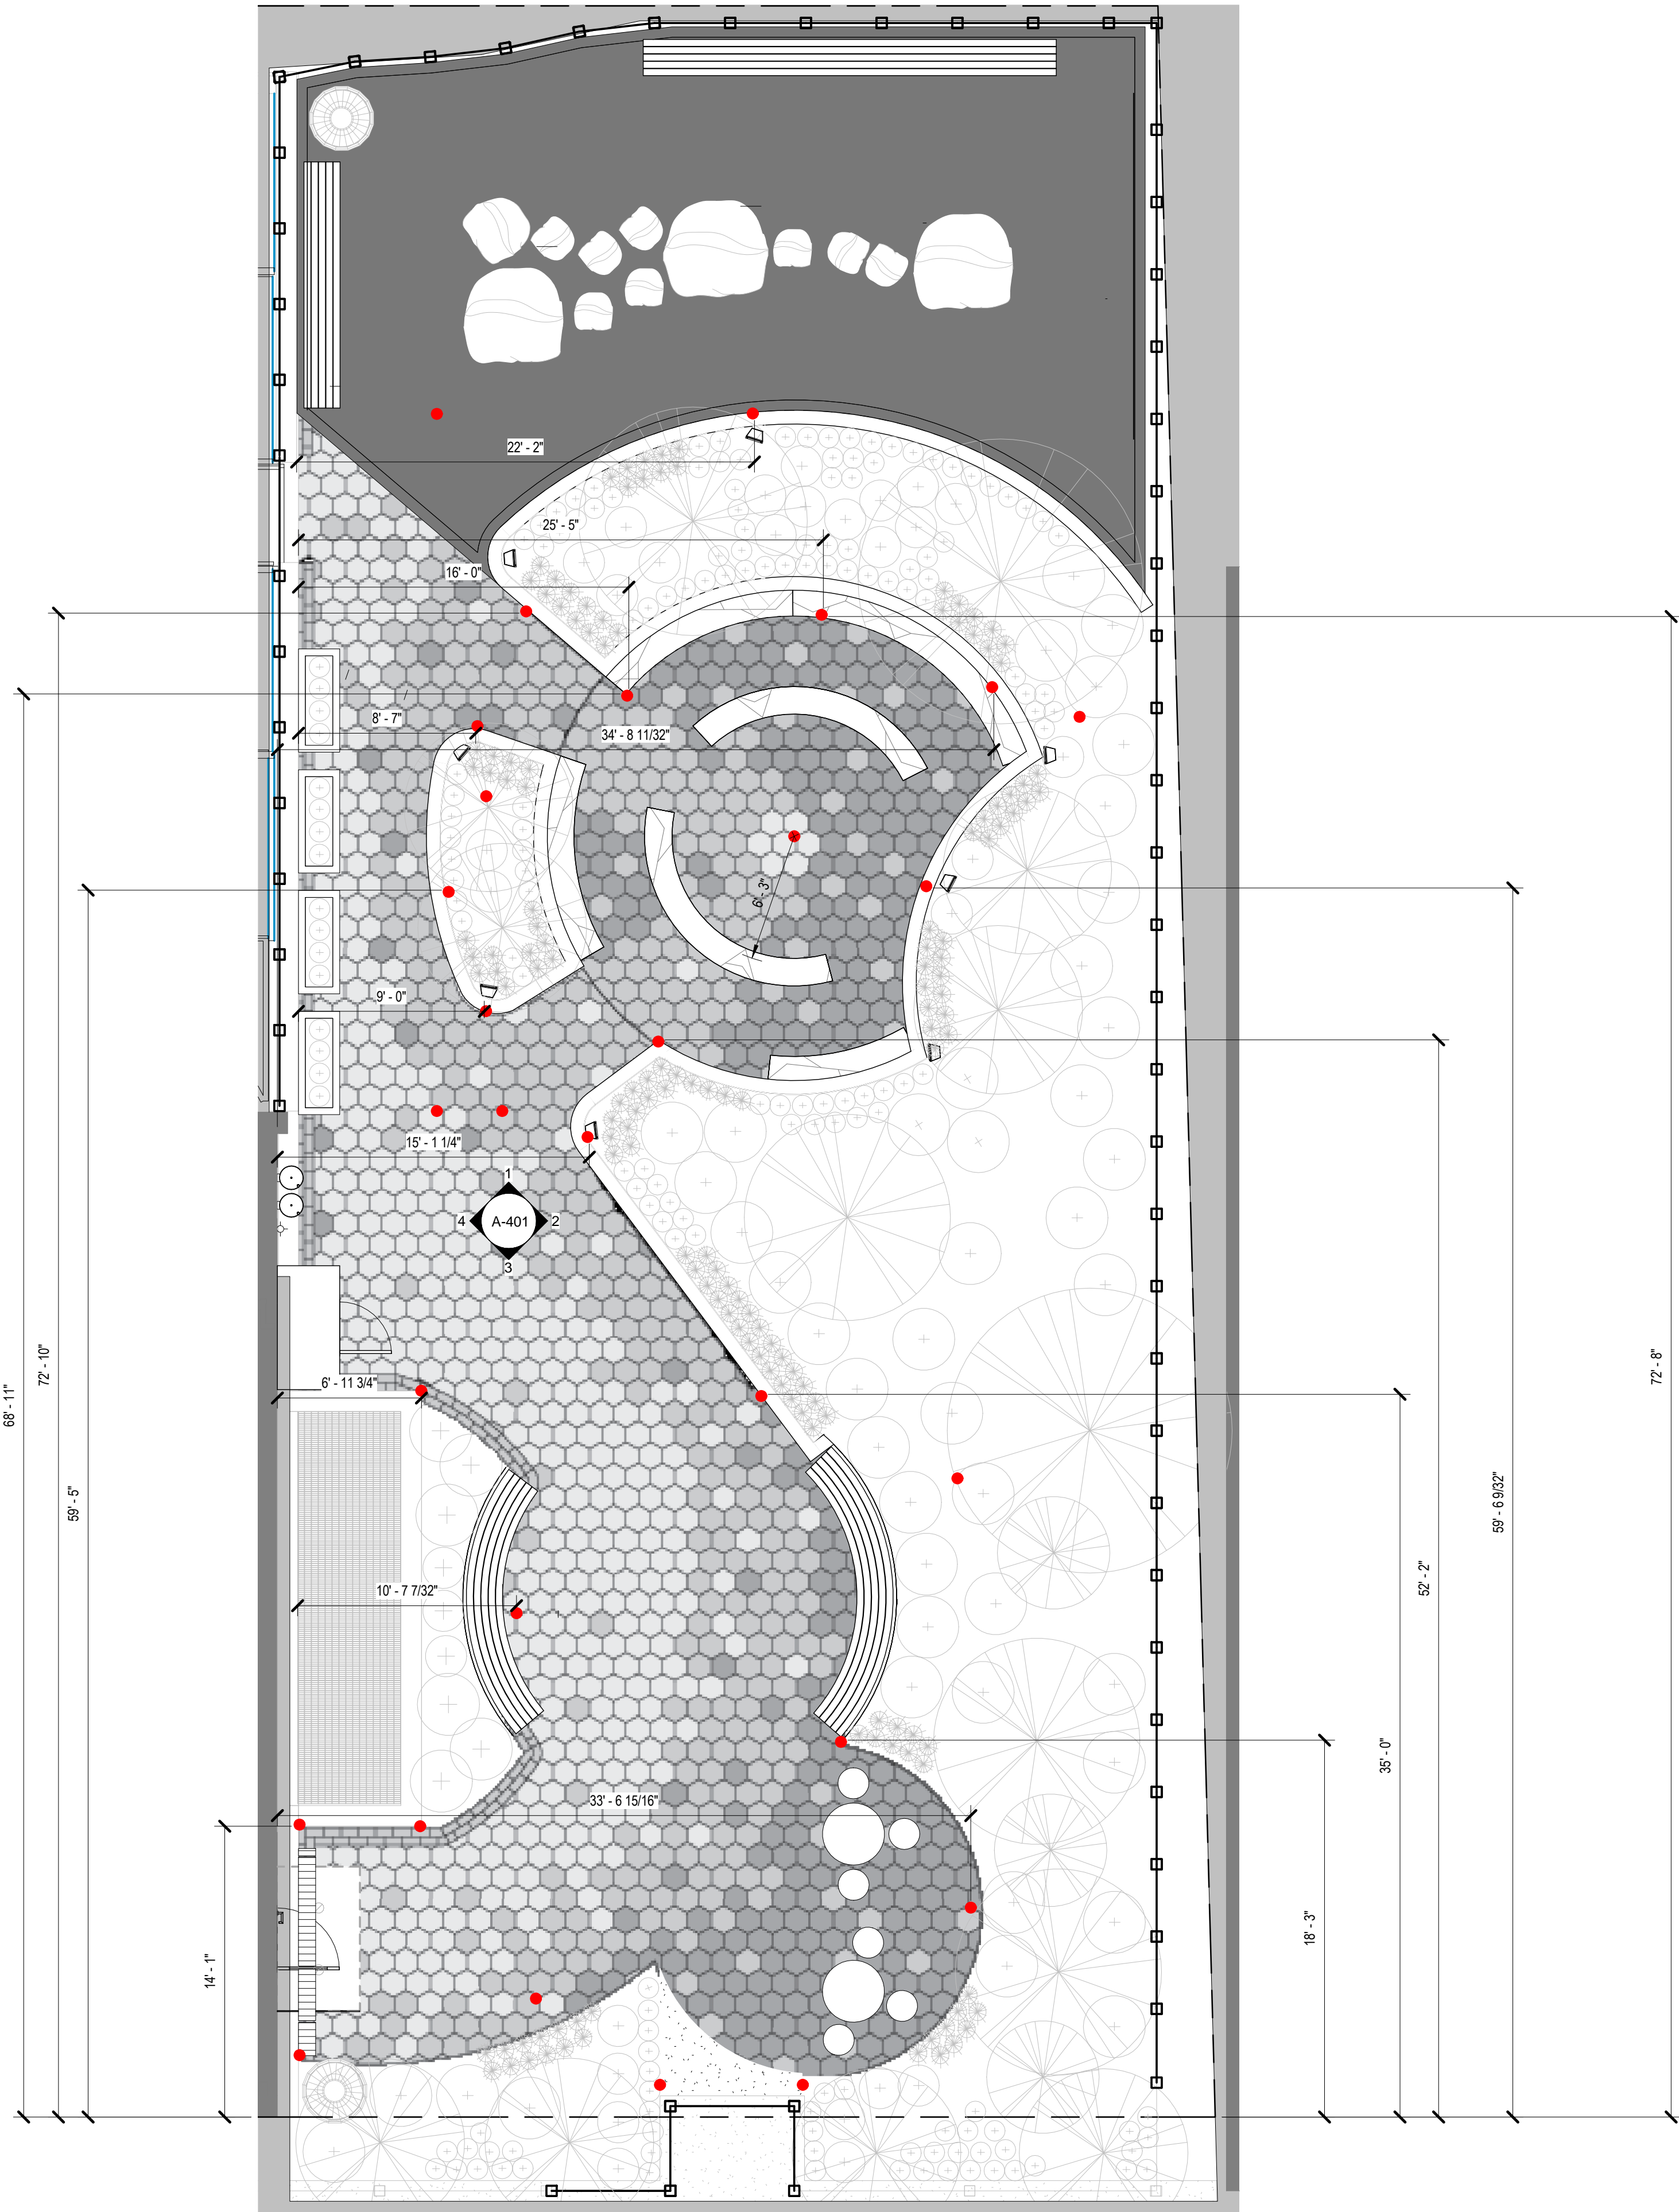

2 ENLARGED GEOMETRIC PLAN
3/16" = 1'-0"

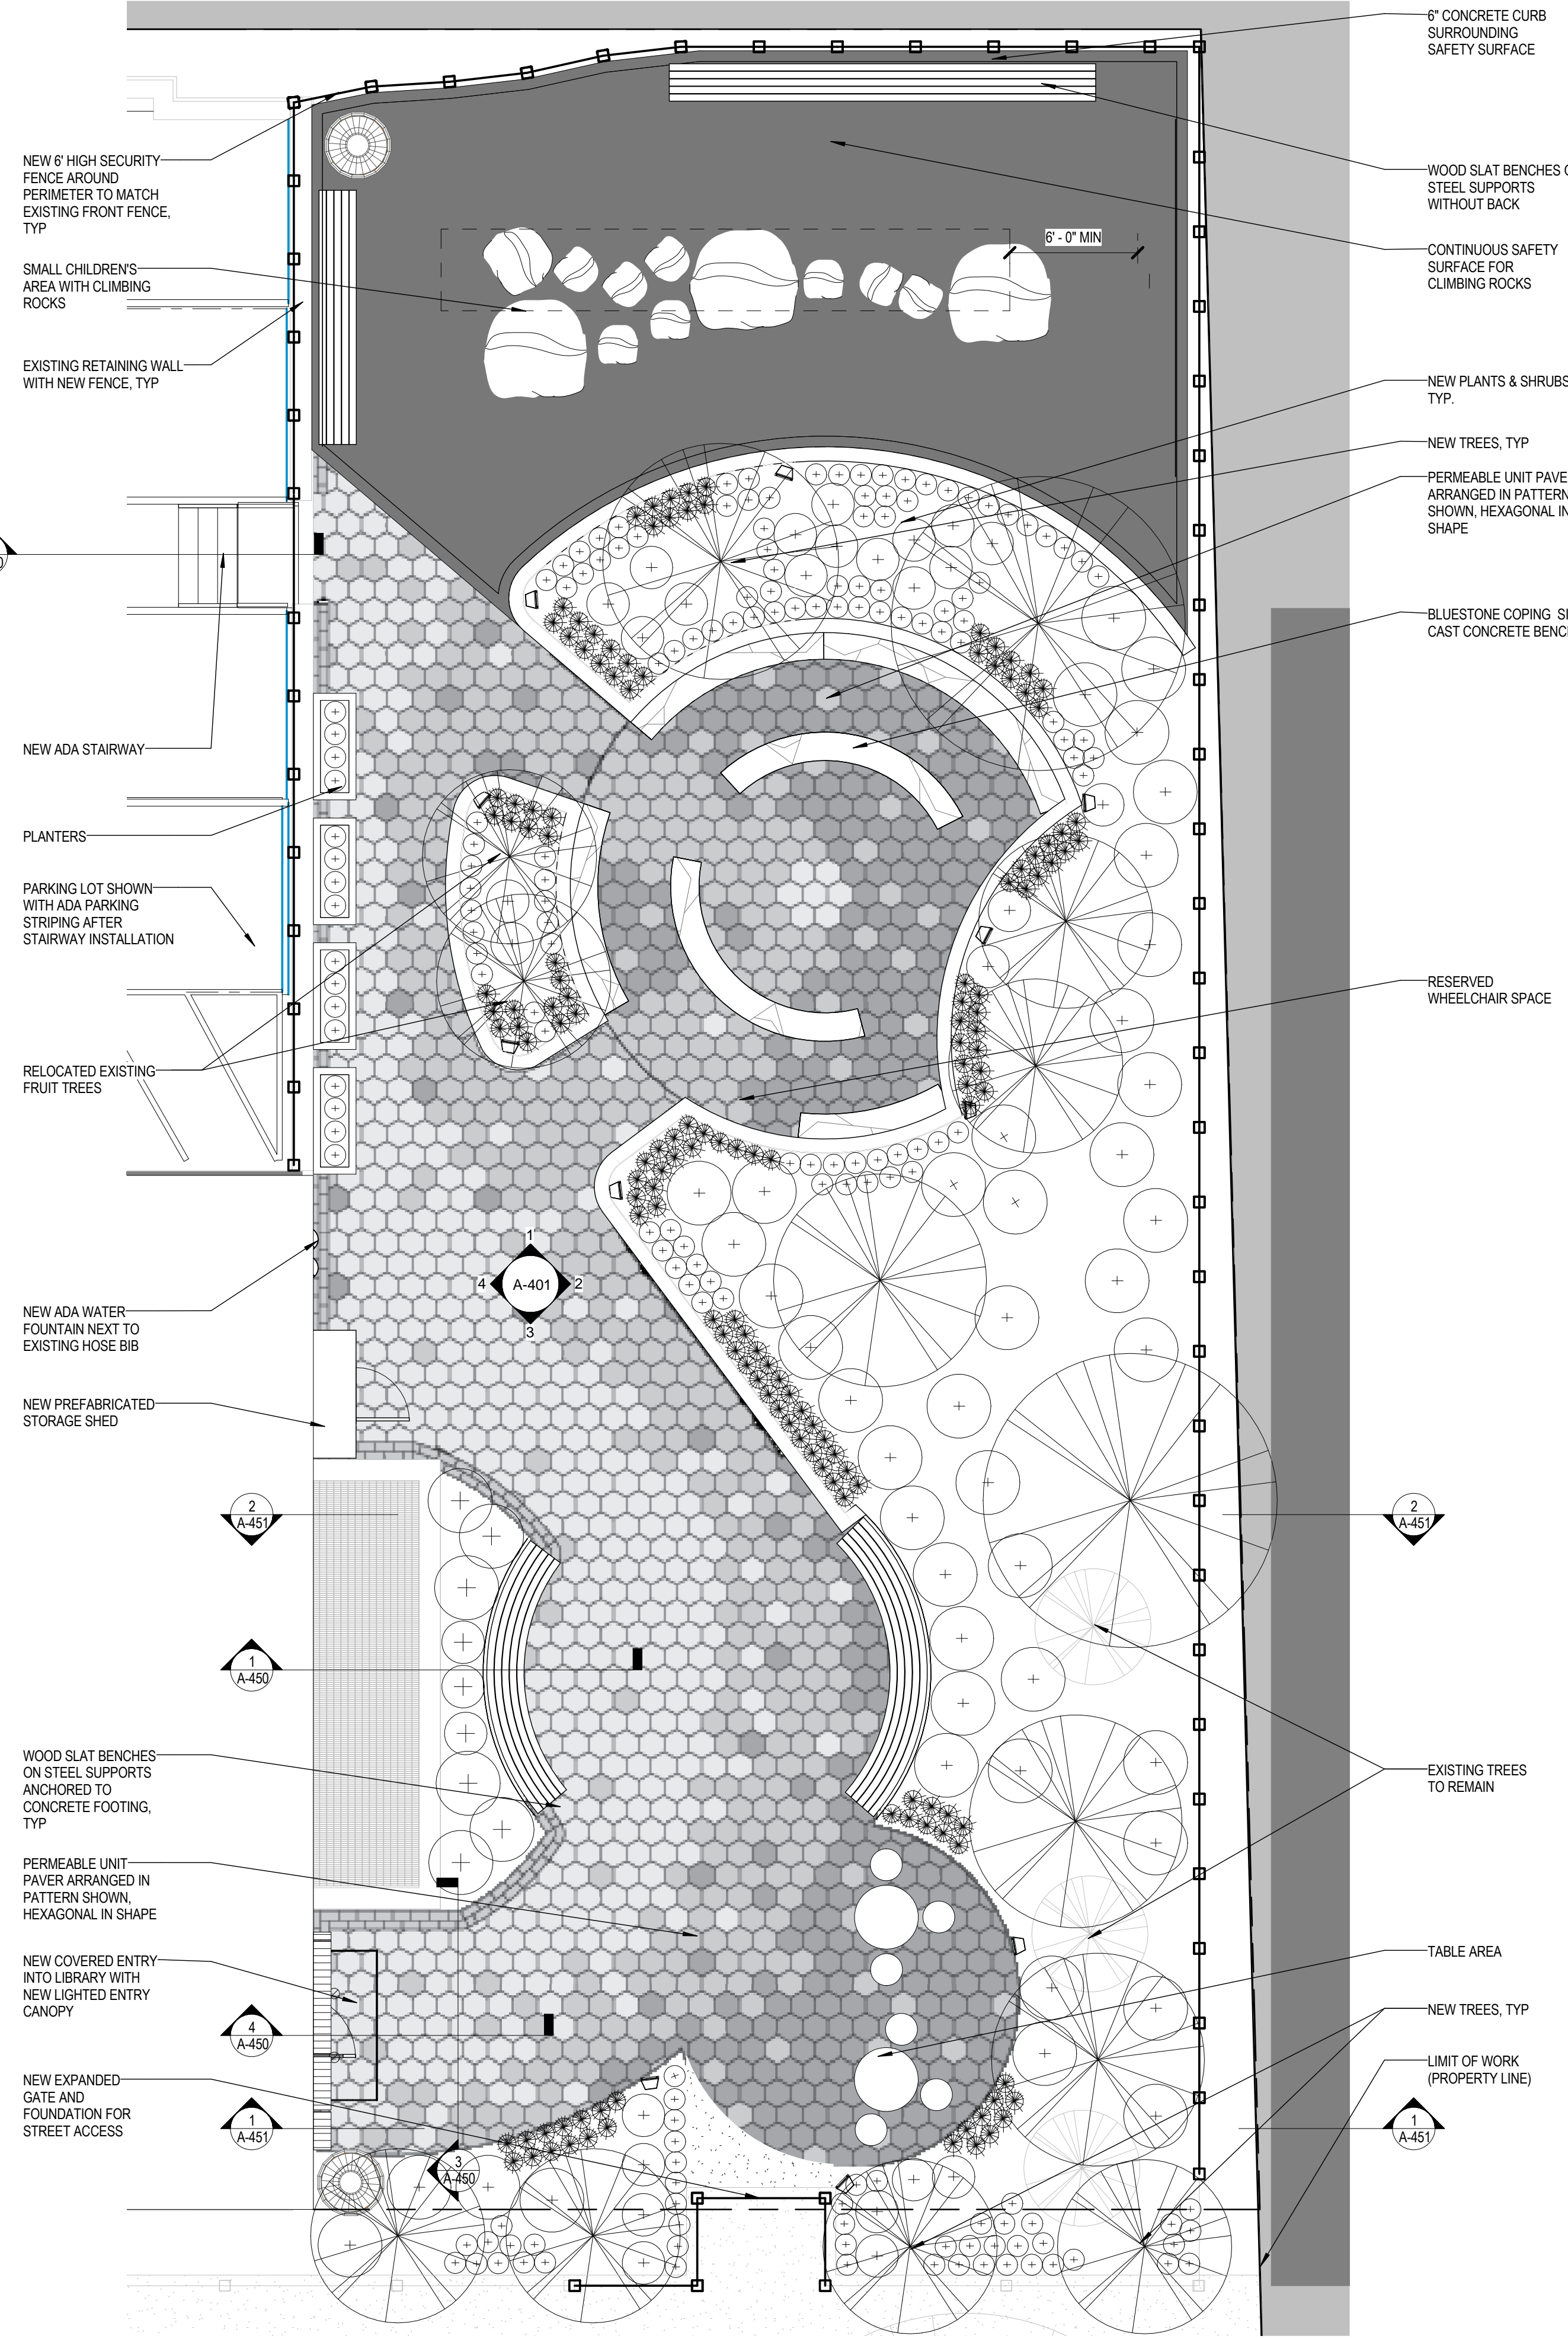

1 ENLARGED SITE PLAN
3/16" = 1'-0"

PROJECT
MAPLETON BRANCH LIBRARY
READING GARDEN

1702 60TH STREET
BROOKLYN, NY 11234
FOR THE BROOKLYN PUBLIC LIBRARY
FMSID NO. LBCT7MPGD



Department of
Design and
Construction
In.House
Design Studio
DIVISION OF PUBLIC BUILDINGS
30-30 Thomson Ave., Long Island City, NY 11101


STRUCTURAL ENGINEER CONSULTANT Address City, ST 12345 T +1 XXX XXX XXXX	M.E.P. CONSULTANT Address City, ST 12345 T +1 XXX XXX XXXX
COST ESTIMATOR CONSULTANT Address City, ST 12345 T +1 XXX XXX XXXX	LIGHTING DESIGN CONSULTANT Address City, ST 12345 T +1 XXX XXX XXXX
LANDSCAPE ARCHITECT CONSULTANT Address City, ST 12345 T +1 XXX XXX XXXX	CIVIL TRAFFIC ENGINEER CONSULTANT Address City, ST 12345 T +1 XXX XXX XXXX
GEOTECHNICAL ENGINEER CONSULTANT Address City, ST 12345 T +1 XXX XXX XXXX	ACOUSTICAL CONSULTANT CONSULTANT Address City, ST 12345 T +1 XXX XXX XXXX
VERTICAL TRANSPORTATION CONSULTANT Address City, ST 12345 T +1 XXX XXX XXXX	FUELING CONSULTANT CONSULTANT Address City, ST 12345 T +1 XXX XXX XXXX
ENVIRONMENTAL CONSULTANT CONSULTANT Address City, ST 12345 T +1 XXX XXX XXXX	SIGNAGE CONSULTANT CONSULTANT Address City, ST 12345 T +1 XXX XXX XXXX

DOB APPROVAL STAMP

DOB BSCAN STICKER

1	1	ISSUED FOR SCHEMATIC DESIGN	09/19/2017
ISSUE #	REV #	DESCRIPTION	DATE

FOR REFERENCE

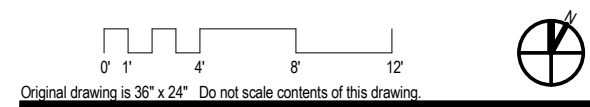


PROJECT STATUS
DESIGN DEVELOPMENT

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SHEET TITLE
DRAINAGE PLAN

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DATE: 2017-09-15
DRAWN BY: ACS
CHECKED BY: JF
DRAWING NUMBER:

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A-004.00

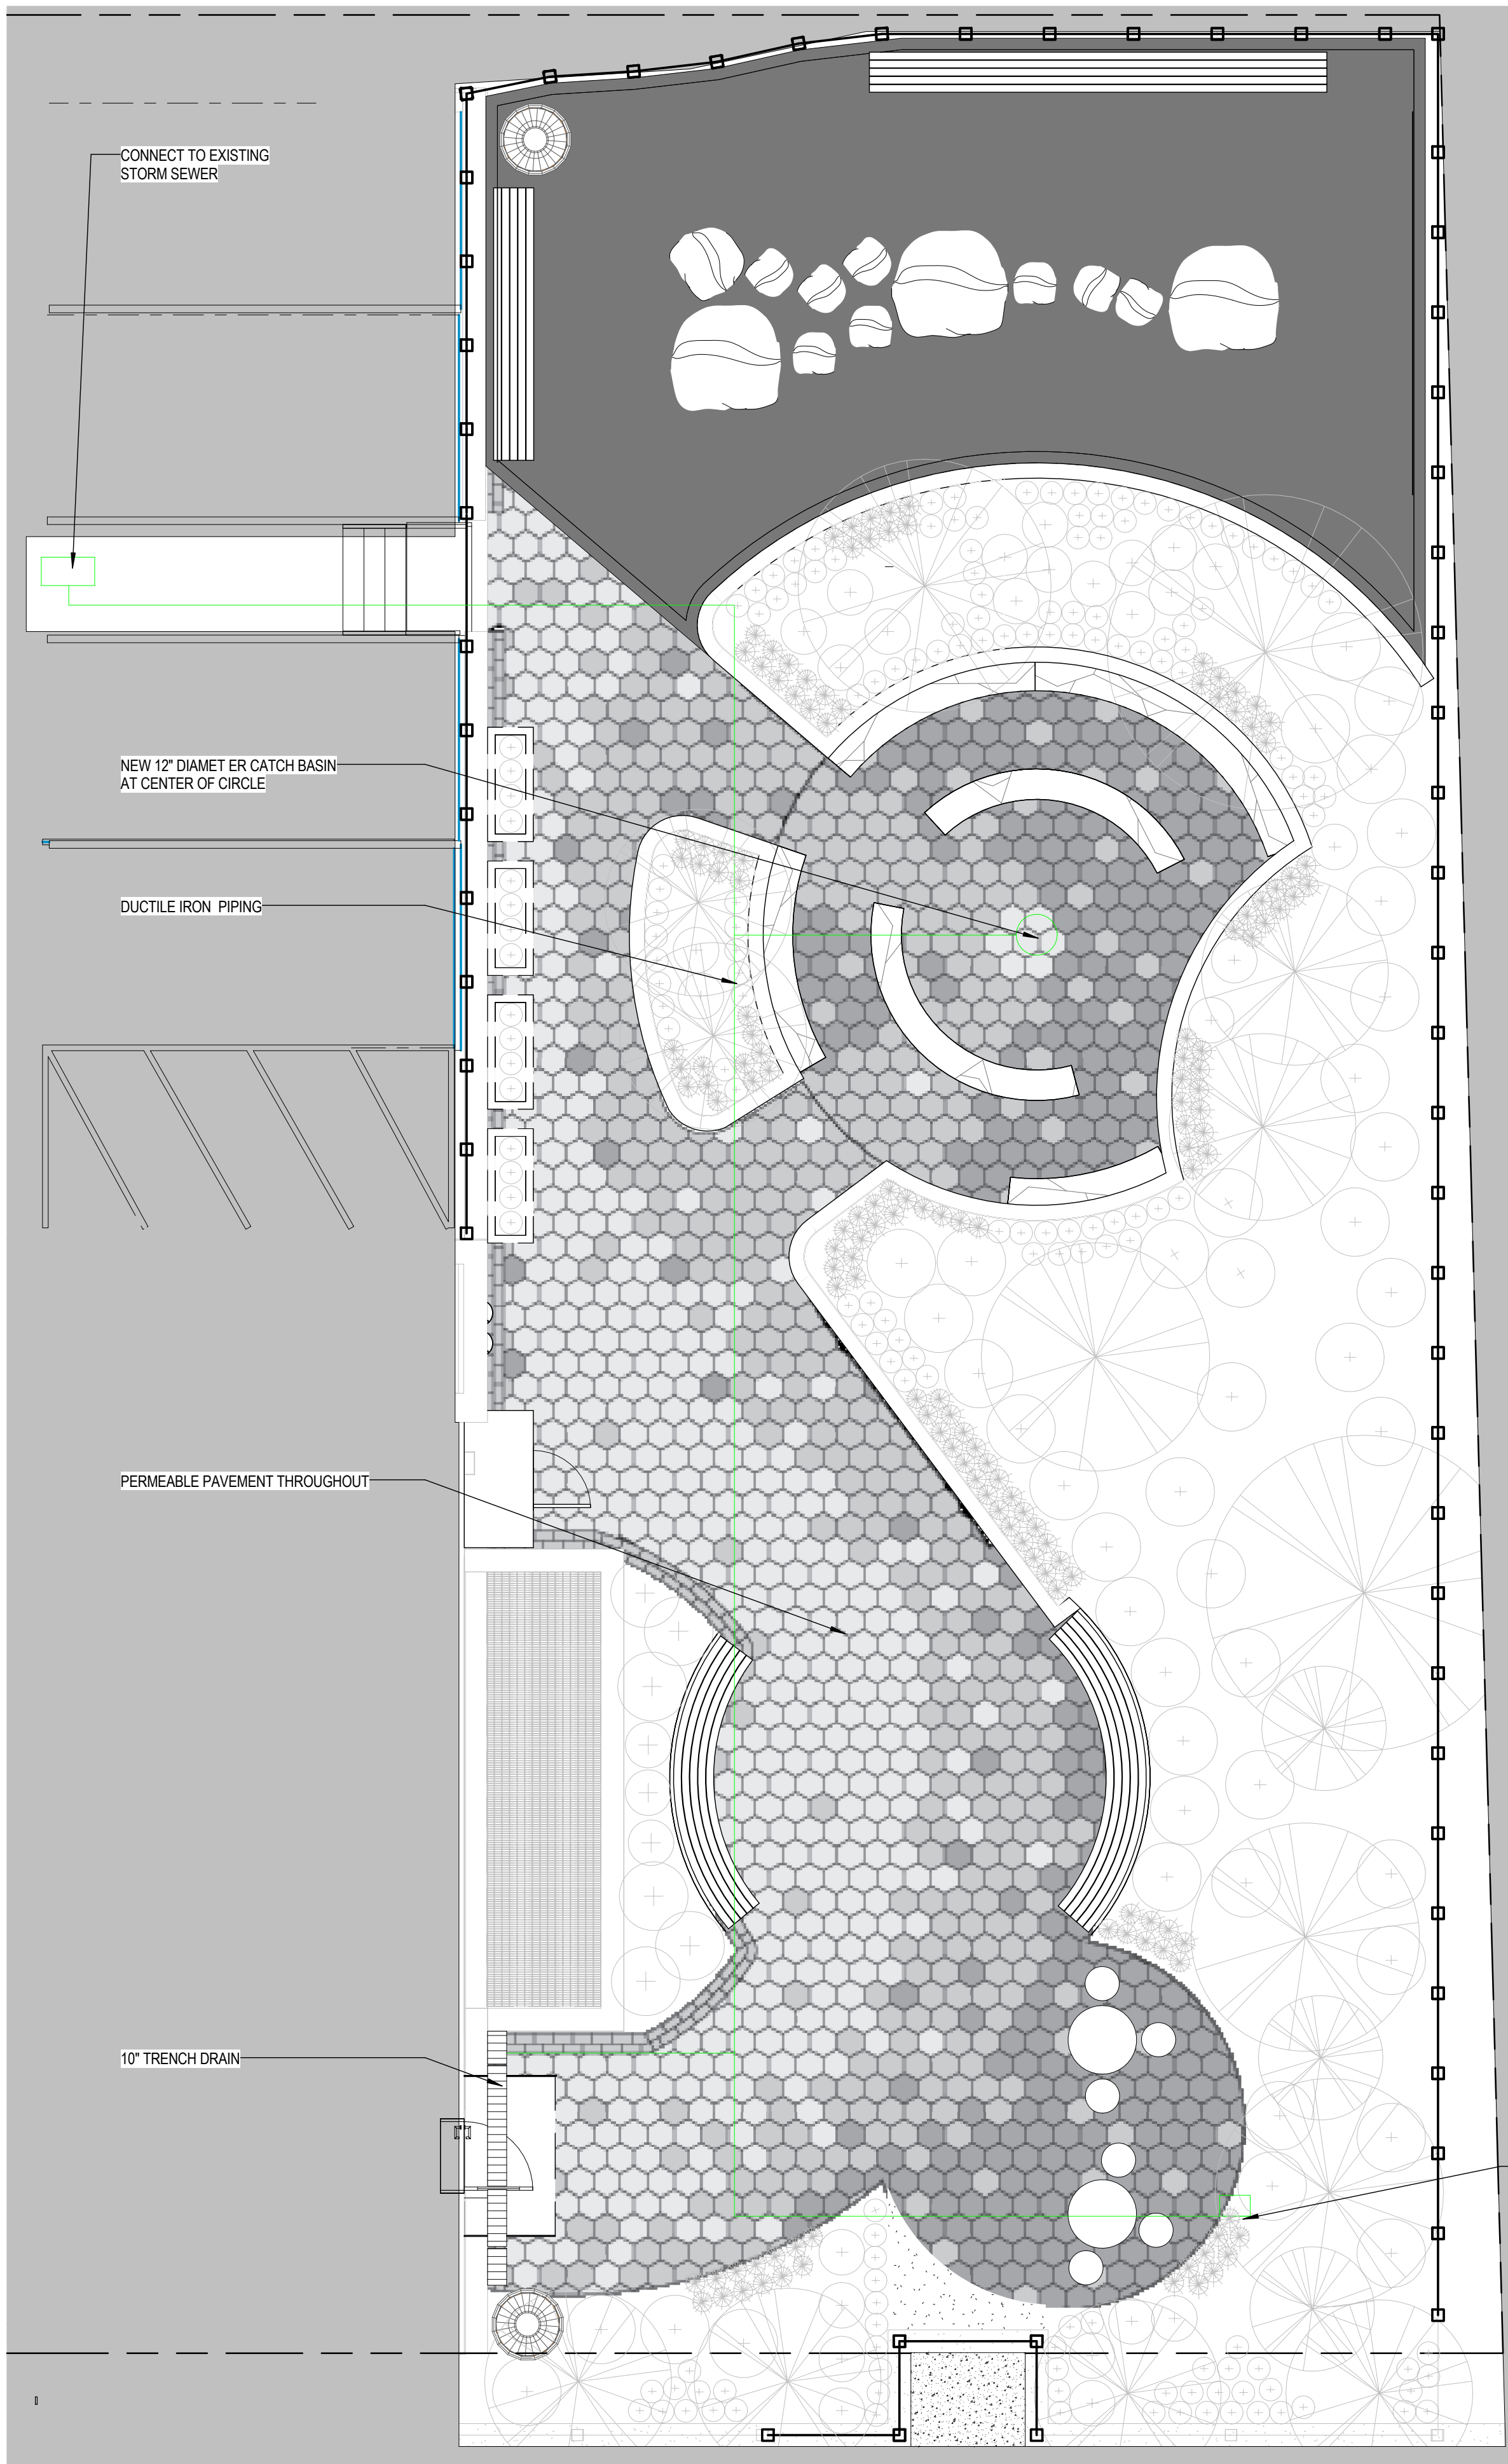


1 DRAINAGE PLAN
3/16" = 1'-0"

STRUCTURAL ENGINEER CONSULTANT Address City, ST 12345 T +X XXX XXX XXXX	M.E.P. CONSULTANT Address City, ST 12345 T +X XXX XXX XXXX
COST ESTIMATOR CONSULTANT Address City, ST 12345 T +X XXX XXX XXXX	LIGHTING DESIGN CONSULTANT Address City, ST 12345 T +X XXX XXX XXXX
LANDSCAPE ARCHITECT CONSULTANT Address City, ST 12345 T +X XXX XXX XXXX	CIVIL TRAFFIC ENGINEER CONSULTANT Address City, ST 12345 T +X XXX XXX XXXX
GEOTECHNICAL ENGINEER CONSULTANT Address City, ST 12345 T +X XXX XXX XXXX	ACOUSTICAL CONSULTANT CONSULTANT Address City, ST 12345 T +X XXX XXX XXXX
VERTICAL TRANSPORTATION CONSULTANT Address City, ST 12345 T +X XXX XXX XXXX	FUELING CONSULTANT CONSULTANT Address City, ST 12345 T +X XXX XXX XXXX
ENVIRONMENTAL CONSULTANT CONSULTANT Address City, ST 12345 T +X XXX XXX XXXX	SIGNAGE CONSULTANT CONSULTANT Address City, ST 12345 T +X XXX XXX XXXX

DOB APPROVAL STAMP

DOB BSCAN STICKER

1	1	ISSUED FOR SCHEMATIC DESIGN	09/15/2017
ISSUE #	REV #	DESCRIPTION	DATE

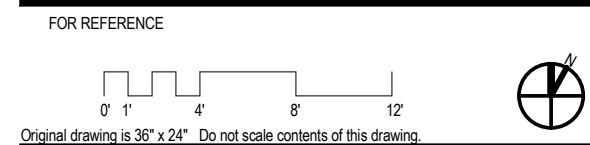


PROJECT STATUS
DESIGN DEVELOPMENT

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SHEET TITLE
ELEVATIONS

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2
60TH STREET ELEVATION
3/16" = 1'-0"




1
17TH AVENUE ELEVATION
3/16" = 1'-0"

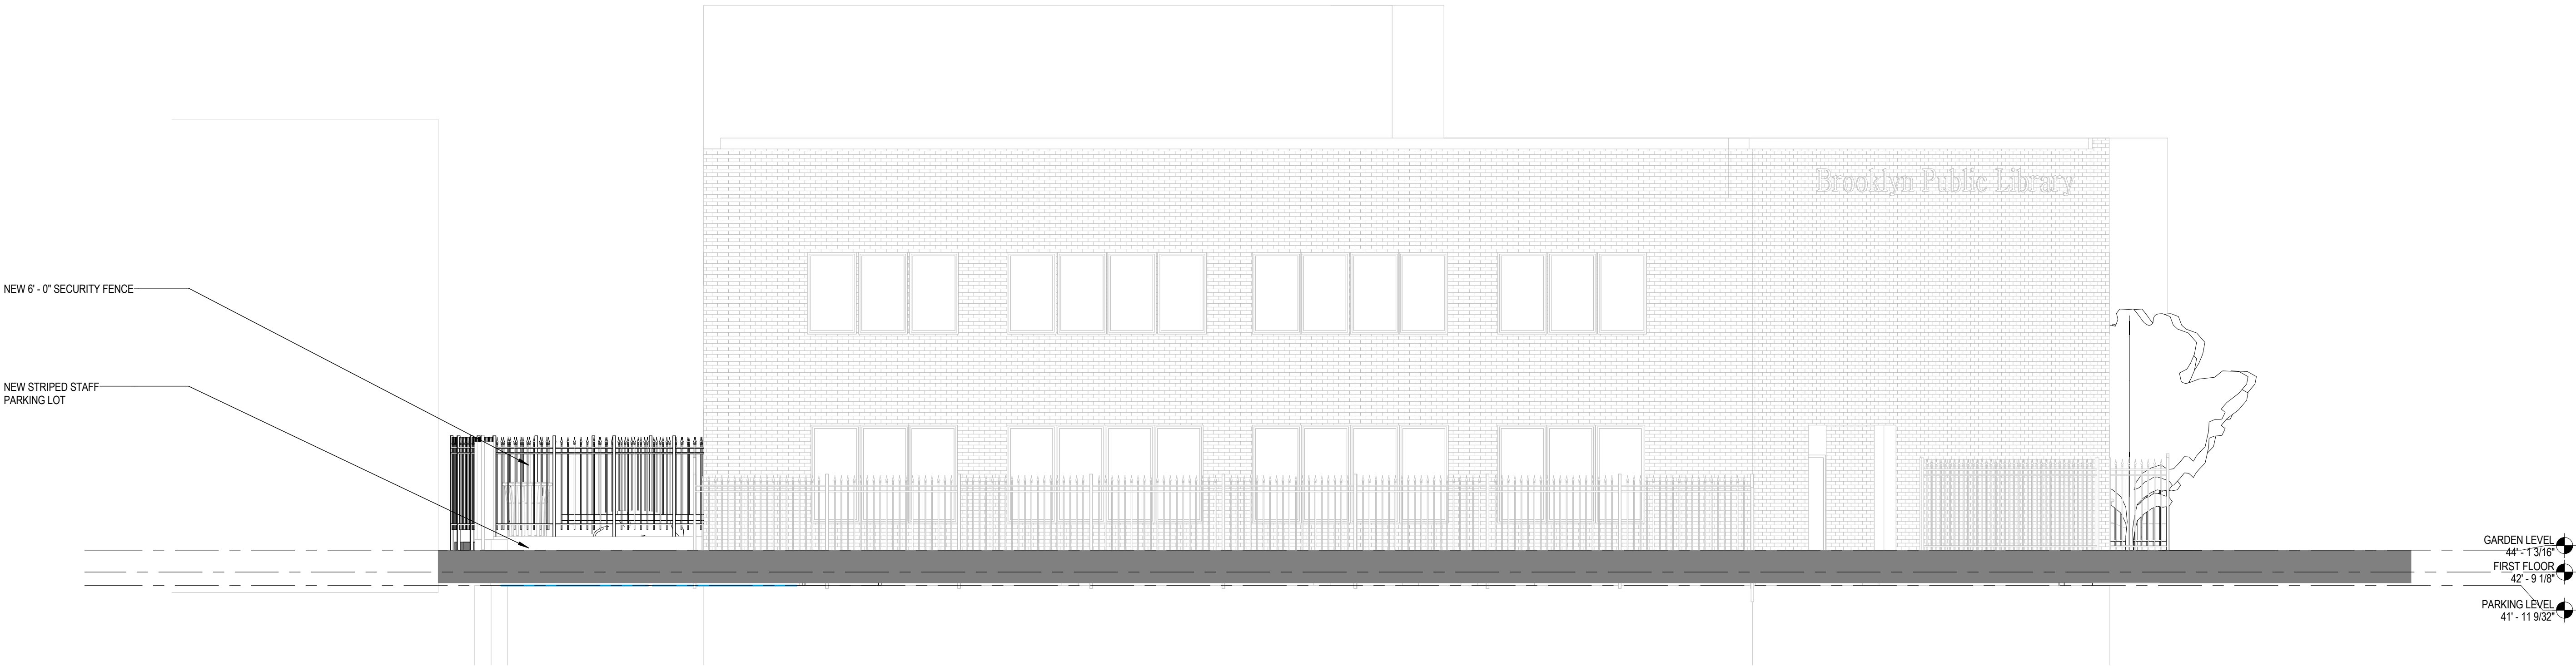4/18/2018 7:52:33 PM


STRUCTURAL ENGINEER CONSULTANT	M.E.P. CONSULTANT
Address City, ST 12345 T +X XXX.XXX.XXXXX	Address City, ST 12345 T +X XXX.XXX.XXXXX
COST ESTIMATOR CONSULTANT	LIGHTING DESIGN CONSULTANT
Address City, ST 12345 T +X XXX.XXX.XXXXX	Address City, ST 12345 T +X XXX.XXX.XXXXX
LANDSCAPE ARCHITECT CONSULTANT	CIVIL TRAFFIC ENGINEER CONSULTANT
Address City, ST 12345 T +X XXX.XXX.XXXXX	Address City, ST 12345 T +X XXX.XXX.XXXXX
GEOTECHNICAL ENGINEER CONSULTANT	ACOUSTICAL CONSULTANT
Address City, ST 12345 T +X XXX.XXX.XXXXX	Address City, ST 12345 T +X XXX.XXX.XXXXX
VERTICAL TRANSPORTATION CONSULTANT	FUELING CONSULTANT CONSULTANT
Address City, ST 12345 T +X XXX.XXX.XXXXX	Address City, ST 12345 T +X XXX.XXX.XXXXX
ENVIRONMENTAL CONSULTANT CONSULTANT	STORAGE CONSULTANT CONSULTANT
Address City, ST 12345 T +X XXX.XXX.XXXXX	Address City, ST 12345 T +X XXX.XXX.XXXXX

DOB APPROVAL STAMP


DOB BSCAN STICKER

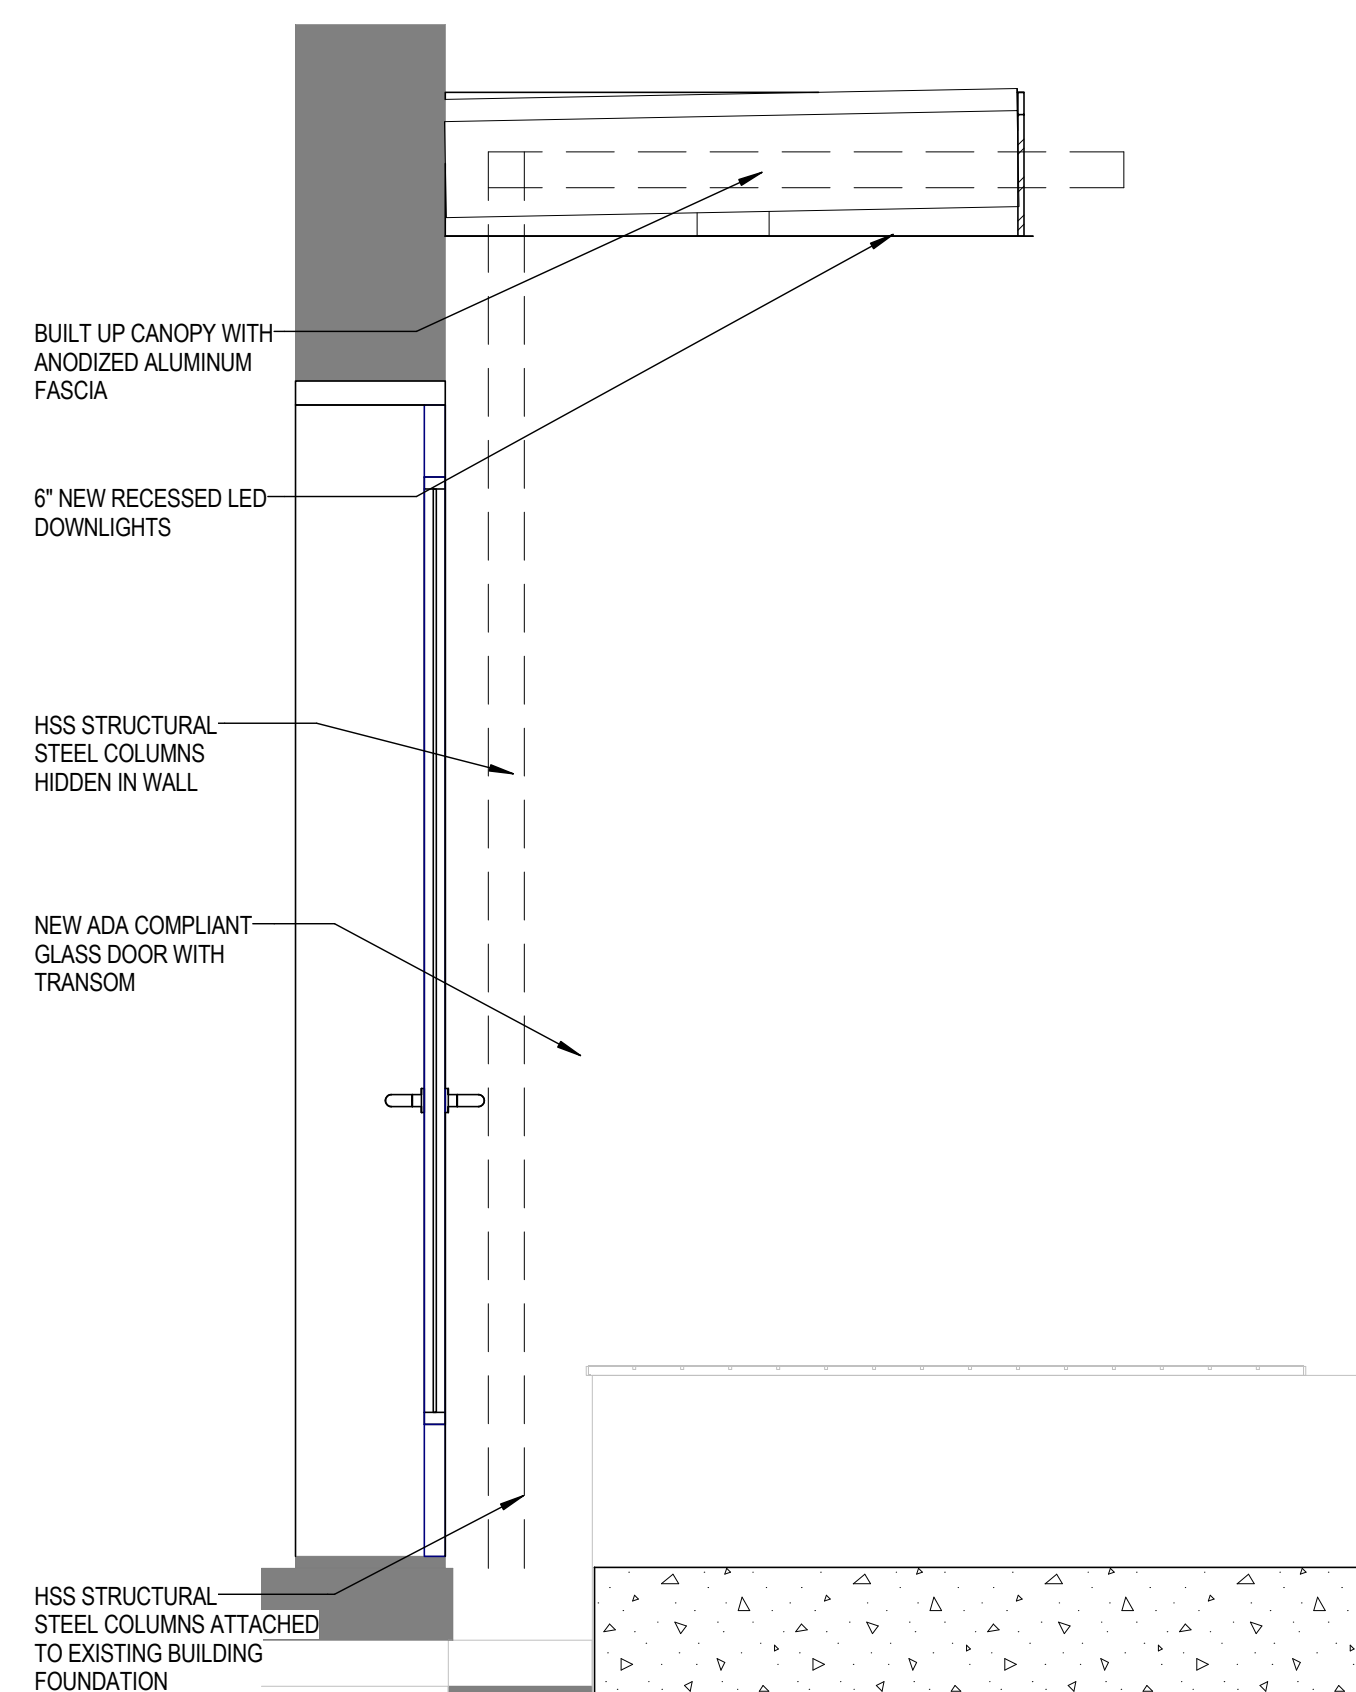


4 SECTION @ CANOPY LOOKING SE
3/4" = 1'-0"

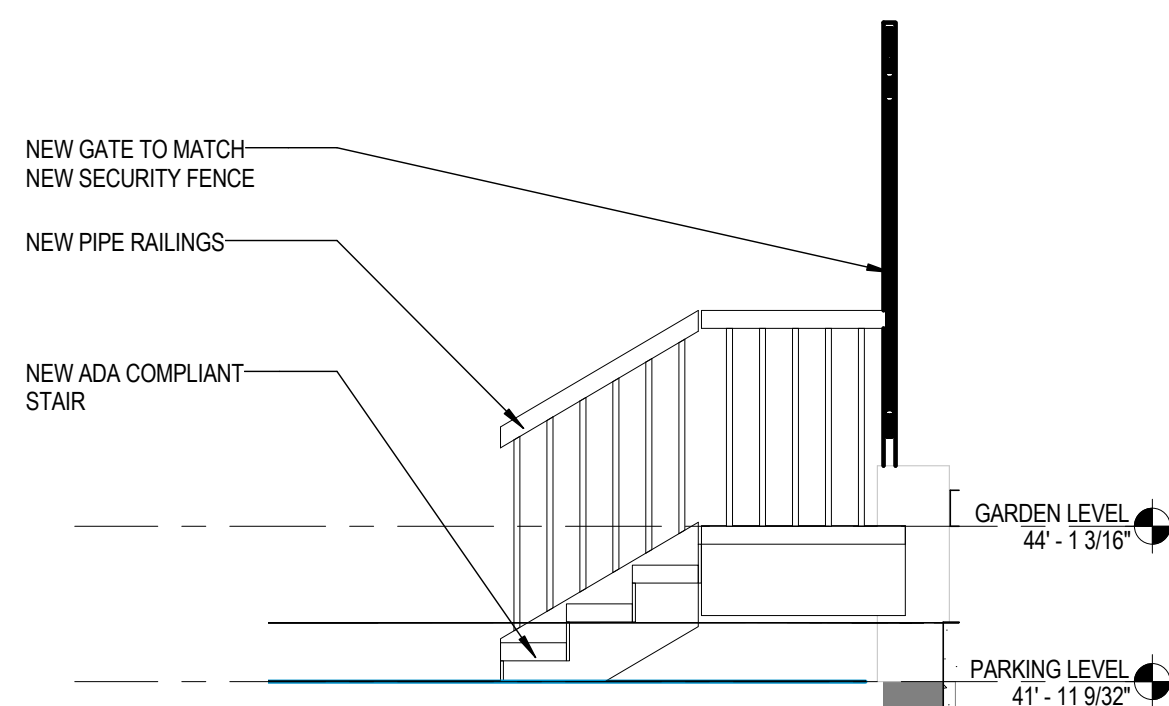

2 STAIR SECTION
3/8" = 1'-0"

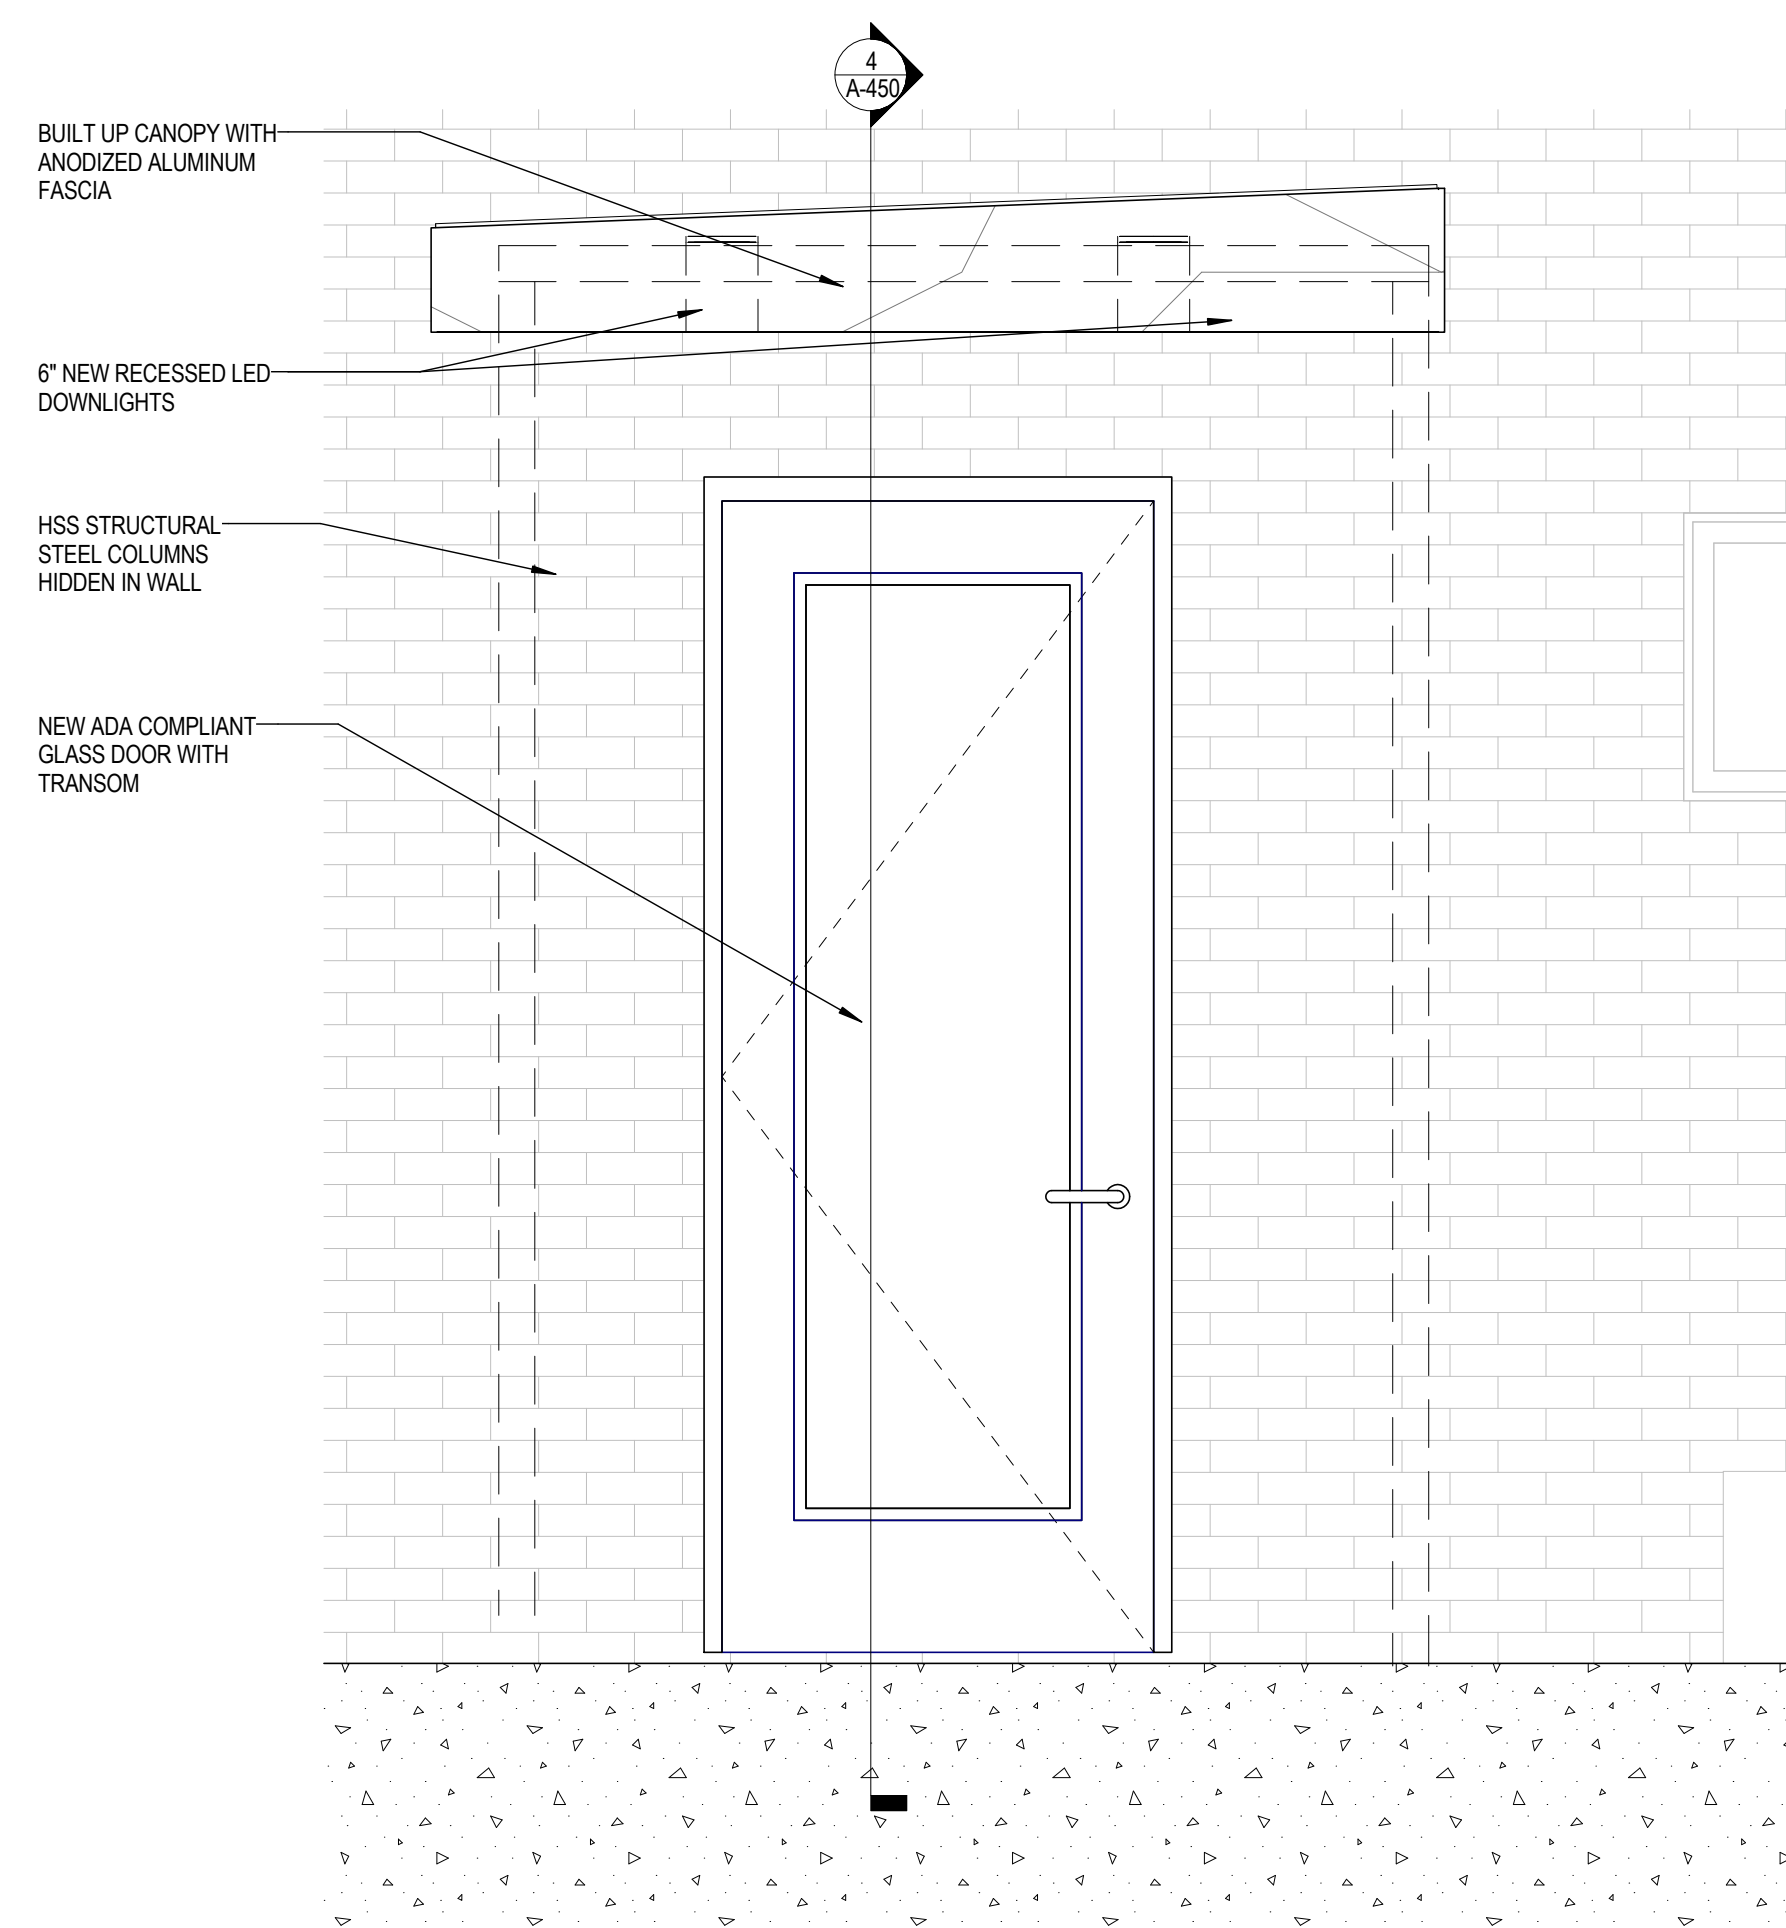


3 ELEVATION @ CANOPY LOOKING NE
3/4" = 1'-0"

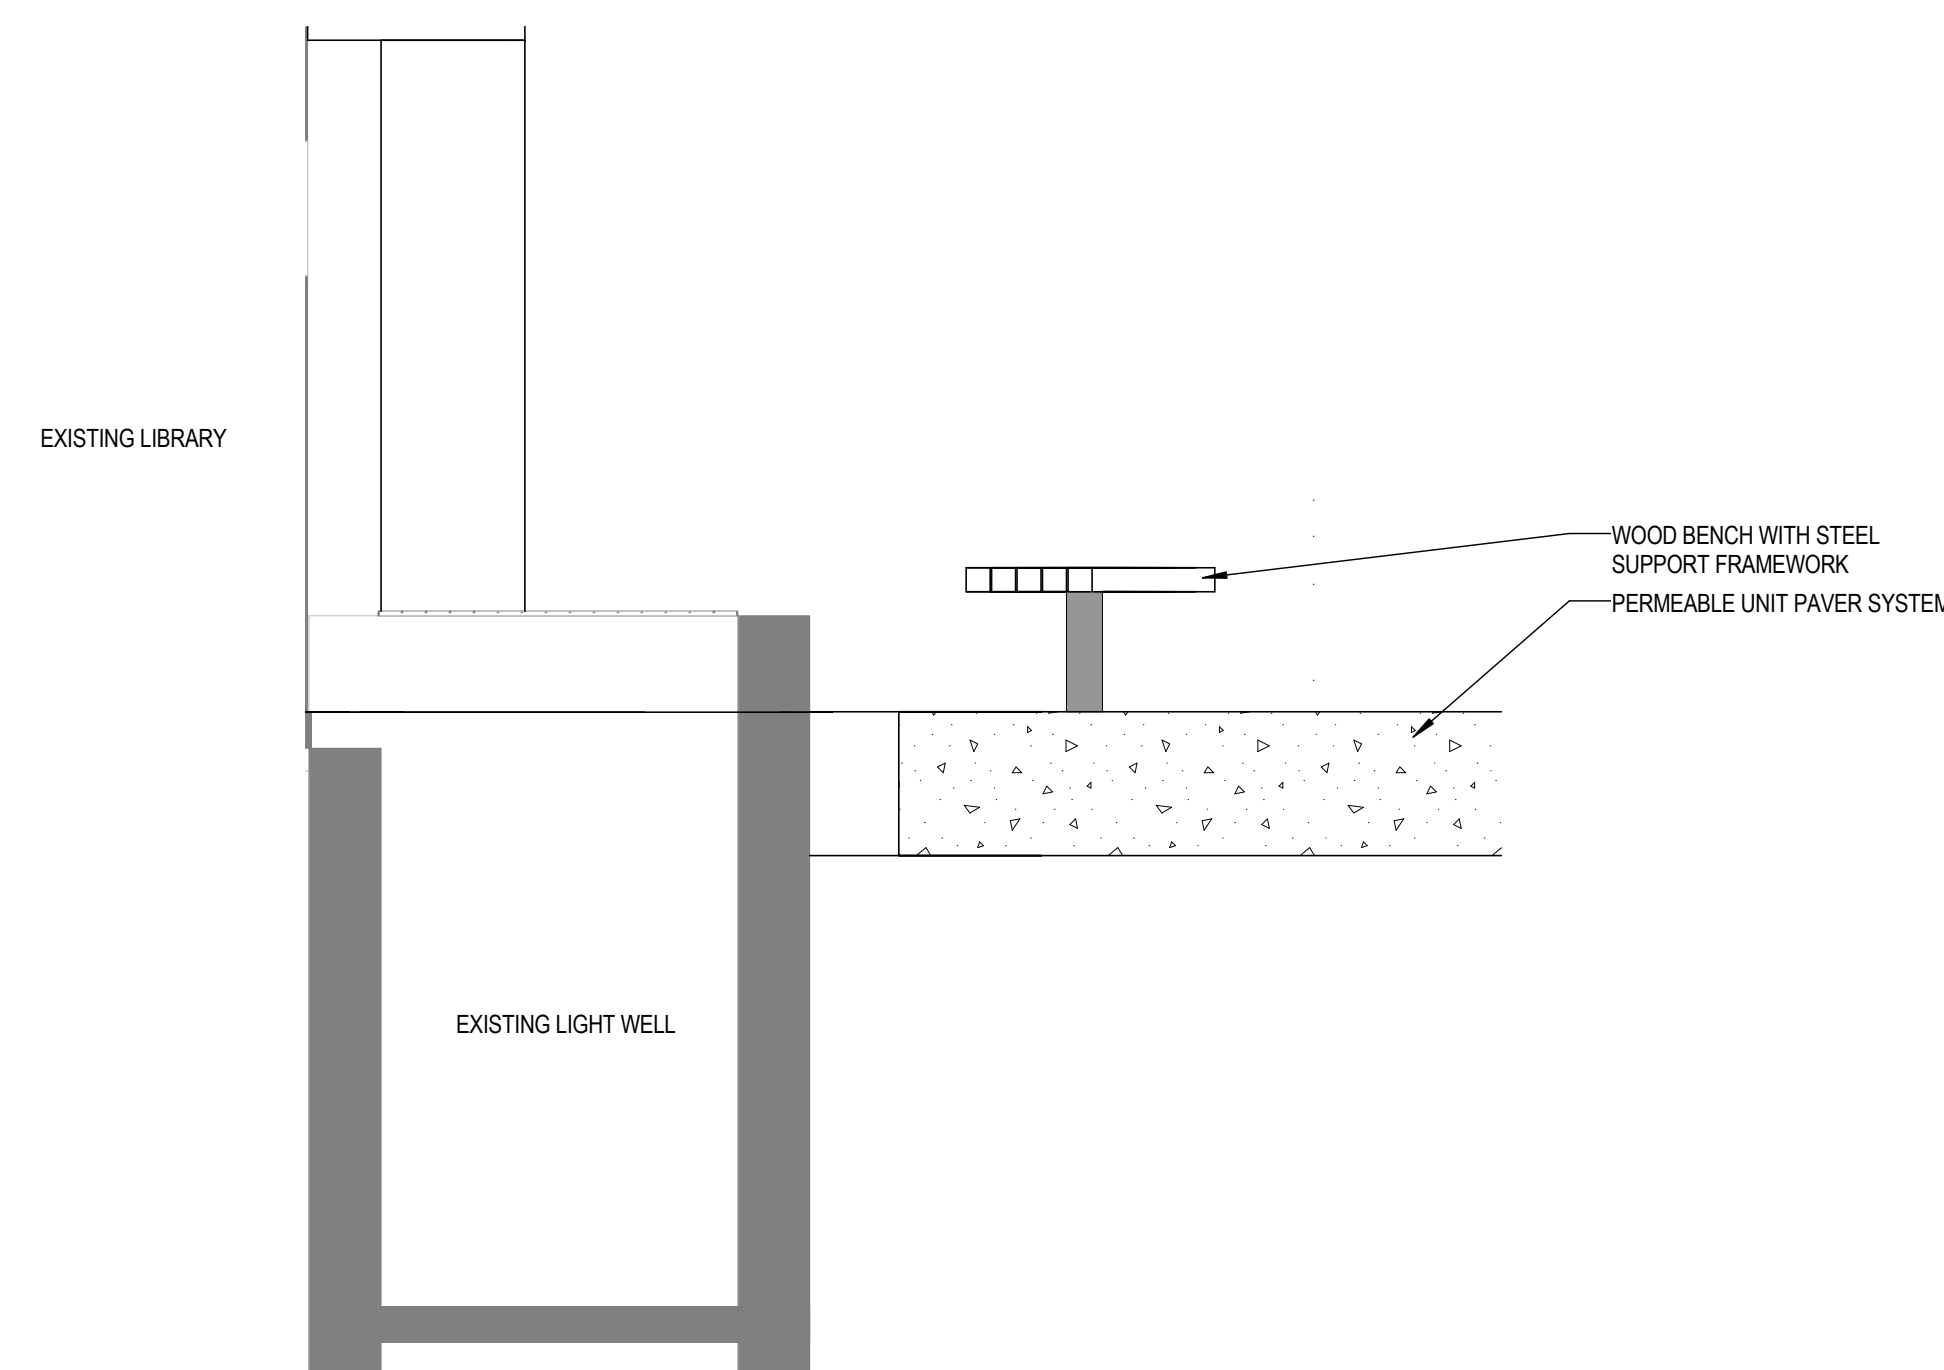

1 SECTION @ BENCH LOOKING SE

1	1	ISSUED FOR SCHEMATIC DESIGN	09/15
ISSUE #	REV #	DESCRIPTION	

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PROJECT STATUS

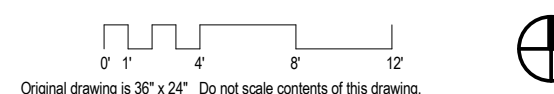DESIGN DEVELOPMENT

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SHEET TITLE
DETAILS AS NOTED

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	CHECKED BY:	Che
	DRAWING NUMBER:	

SEAL & SIGNATURE

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A-450.00

